

#### **Historic Preservation Services**

Community Development & Neighborhood Services 281 North College Avenue P.O. Box 580 Fort Collins, CO 80522.0580

970.416.4250 preservation@fcgov.com fcgov.com/historicpreservation

# CERTIFICATE OF APPROPRIATENESS – Minor Alteration ISSUED: April 27, 2021 EXPIRATION: April 27, 2022

Progressive Old Town 5 Old Town Square Fort Collins, CO 80524

#### Dear Property Owner:

This letter provides you with certification that proposed work to your designated Fort Collins landmark property, the H.C. Howard Block at 214 E. Mountain Avenue/3 Old Town Square has been approved by the City's Historic Preservation Division (HPD) because the proposed work appears to be routine in nature with minimal effects to the historic resource, and meets the requirements of Chapter 14, <u>Article IV</u> of the Fort Collins Municipal Code. Please note conditions on the two proposed work items on the building's exterior.

#### The alterations reviewed include:

- Minor carpentry repair to wood store front, subject to the following conditions:
  - Condition 1: Replacement of wood features due to deterioration will be limited to the wood framing at grade that was previously noted as deteriorated. Replacement shall be in-kind (i.e., same dimensions and same or similar wood material). If, after removal, field conditions require replacement of further wood framing (kick plate, window framing, etc.), the applicant will contact Historic Preservation Services immediately for a consultation prior to altering the approved work.
  - Condition 2: Wood repair that requires heavy sanding or other abrasive measures will not be used.
- Repaint of wood elements of exterior
  - Condition 1: Application of water sealants, including waterproof wood treatments or waterproof paints is generally discouraged and will require additional consultation with Historic Preservation Services.
  - Highly abrasive paint removal methods such as use of rotary sanders or sandblasting are discouraged due to likelihood of damage to the underlying material and will require additional consultation with Historic Preservation Services.

Notice of the approved application has been provided to building and zoning staff to facilitate the processing of any permits that are needed for the work. Please consider National Park Service Preservation Brief #10, *Exterior Paint Problems on Historic Woodwork* as you complete this project.


Please note that work beyond that indicated in your permit application/correspondence requires additional approval.


If the approved work is not completed prior to the expiration date noted above, you may apply for an extension by contacting staff at least 30 days prior to expiration. Extensions may be granted for up to 12 additional months, based on a satisfactory staff review of the extension request.

If you have any questions regarding this approval, or if I may be of any assistance, please do not hesitate to contact me. I may be reached at <a href="mailto:jbertolini@fcgov.com">jbertolini@fcgov.com</a> or 970-416-4250.


Sincerely,


Jim Bertolini Historic Preservation Planner

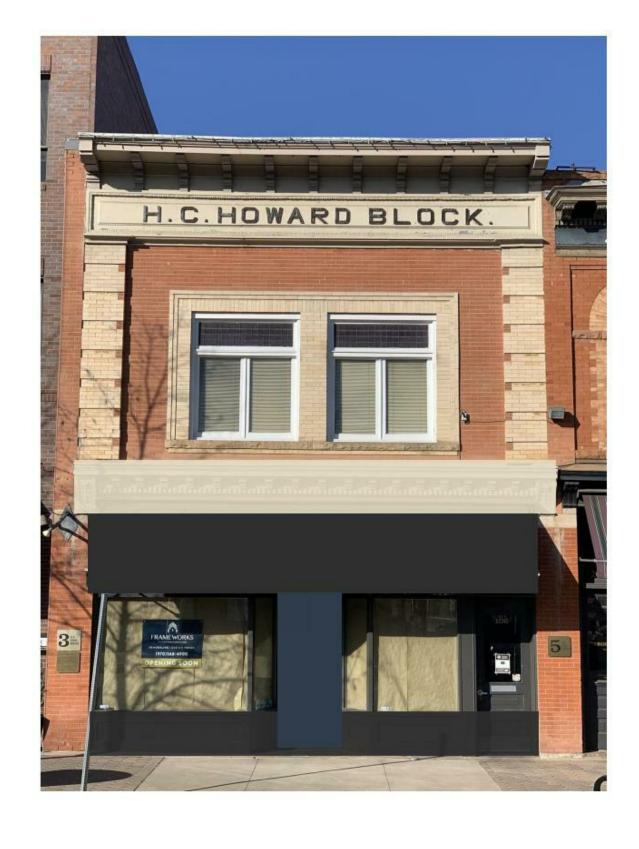


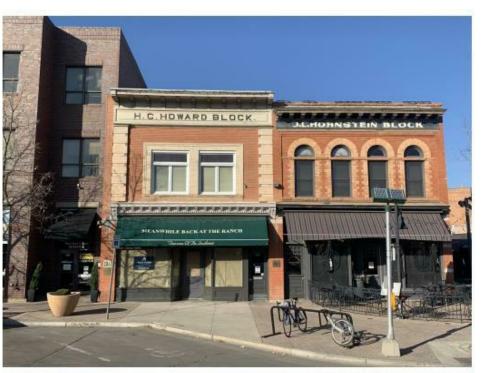

existing south elevation

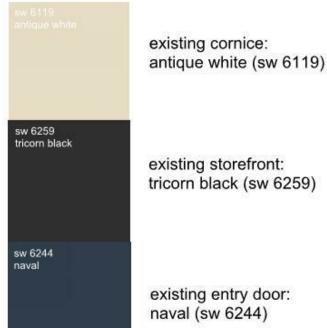

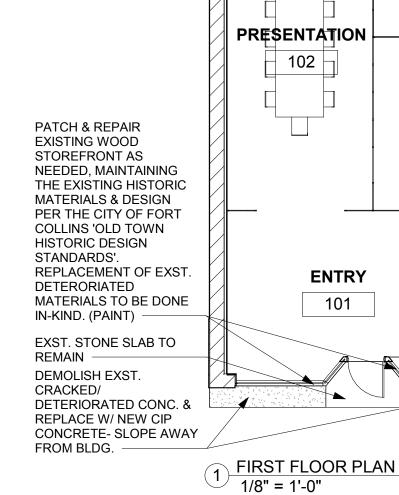


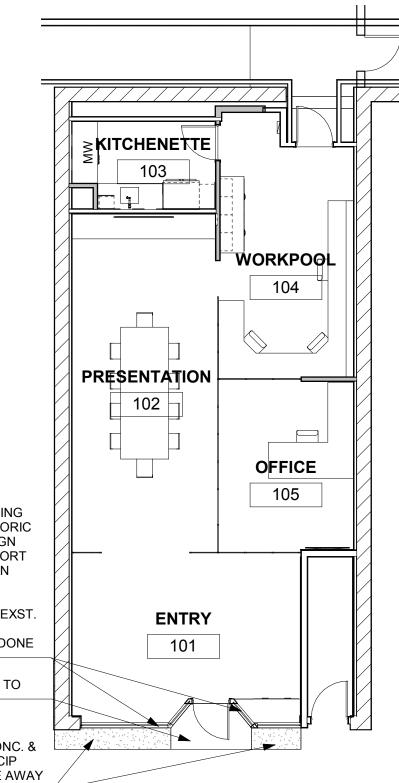


# architectur

715 w. mountain avenue fort collins, colorado 80521

phone: 970.231.1040 e-mail: heidi@studio-s-arch.com

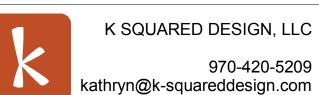

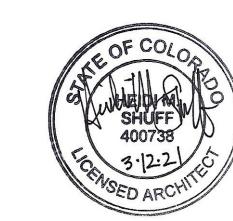

# **ABBREVIATIONS**

N.I.C.

N.T.S.

NOM.

O.A.

O.C.

O.D.

O.H.

P.T.

P.TL.

PNT.

R.D.

R.O.

R.T.U.

REINF.

RESIL

RLG.

RND.

S.AC.TL.

RW.

S.C.

S.D.

S.S.

STL.

T.P.

T.O.

TYP.

U.N.O.

V.C.T.

VERT.

V.T.R.

V.WC.

W/O

WD.

W/

TEMP.

REQ'D

PL.LAM.

PLYWD.

Not in Contract

Outside Diameter

Plastic Laminate

Pressure-Treated

Paper Towel Dispenser

Reinforce or Reinforcing

Resilient (flooring or base)

Suspended Acoustical Tile

Toilet Paper Dispenser

**Unless Noted Otherwise** 

Vinyl Composition Tile

Solid Core (wood)

Tempered (glass)

Soap Dispenser

Stainless Steel

SAIL.CRS. Sailor Course (masonry)

Sheet

Top Of

Typical

Vent

With

Without

Wood

Vertical

Vent Thru Roof

Vinyl Wallcovering

Not to Scale

Nominal

On Center

Overhead

Plywood

Roof Drain

Required

Redwood

Rolling

Round

Rough Opening

Roof - Top Unit

Paint


Overall

A.F.F. Above Finished Floor A.H.U. Air-Handling Unit B.O. Bottom Of B.M. Benchmark C.J. **Control Joint** C.M.U Concrete Masonry Unit C.U. Condensing Unit CAB. Cabinet CER.TL. Ceramic Tile CONT. Continuous D.F. **Drinking Fountain** DBL. Double D.S. Downspout DWG. Drawings E.C. Electrical Conduit E.F. Exhaust Fan E.J. **Expansion Joint** E.W.C. Electric Water Cooler EA. Each E.P.PT. **Epoxy Paint** EQ. Equal EXIST or (E) Existing EXT. Exterior F.D. Floor Drain F.E. Fire Extinguisher F.V. Field Verify FIN. Finish FLR. Floor FTG. Footing GALV. Galvanized GYP.BD. Gypsum Wallboard Handicapped H.C. Hollow Core (Wood) HDR. Header H.M. **Hollow Metal** Horizontal I.D. Inside Diameter INS.STL. Insulated Steel INT. **Masonry Opening** M.O. MANUF. Manufacturer MTL. Metal

ARCHITECTU	RAL SYME	BOLS
Property Line Existing Contour	10	1 A1
New Contour  Easement / Setback	——————————————————————————————————————	Wall Elevation
Sanitary Sewer	SS	Detail
Water Line Gas Line	W	
Storm Drain Datum	SD	Building Section
Spot Elevation Window Type	<del>•</del>	Wall Section
Drawing Title  Drawing Number	(A) —√1 DWG TTL	Grid Line
Sheet Number	DWG TTL	
Scale————————————————————————————————————	ROOM NAME	
Room number		

# **MATERIALS**


Plywood

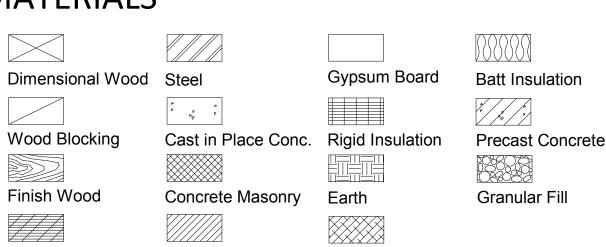

Stone

Brick

# **VICINITY MAP**

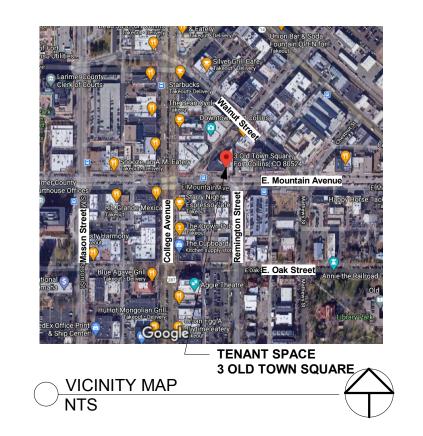

# SITE & BUILDING DATA

Parcel No: Zoning District: Subdivision: Total Tenant Area:

Occupancy Type:

## 3 Old Town Square Property Address: Progressive Old Town Square LLC Property Owner: 9712308013

<u>Legal Description:</u> LOTS A, 17, 16, 15, & 14 & POR LOTS 13, 12, 11, & 10 INBLK 19, FTC & POR OF ABANDONED LINDEN ST IN CITY LOTS A, 17, 16, 15, & 14 & POR LOTS 13, 12, OF FT COLLINS, DESC AS FOLLOWS: BEG AT SW COR BLK 18, FTC, TH N 89 57' 40" E 59.79 FT, N 41 16' 20" E 91.31 FT, Downtown District (D)

10019 - FTC BLK 19 1,092 SF Business Group B

# **DRAWING INDEX**

A0.1 COVER SHEET & PROJECT INFORMATION A1.0 CODE PLANS & CODE ANALYSIS

INTERIORS: I1.1 FIRST FLOOR DEMOLITION PLAN I1.2 FIRST FLOOR PLAN

15.1 KITCHENETTE INTERIOR ELEVATIONS

I6.1 FIRST FLOOR REFLECTED CEILING PLAN MECHANICAL/ PLUMBING: H0.1 HVAC NOTES, LEGEND & INDEX

H2.1 HVAC PLAN, SCHEDULES & DETAILS P0.1 PLUMBING NOTES, LEGEND, SCHEDULES & INDEX P2.1 PLUMBING FLOOR PLANS

E-1 POWER AND LIGHTING REMODEL PLANS AND SCHEDULES

# **GENERAL NOTES**

ALL CONSTRUCTION SHALL BE IN ACCORDANCE WITH THE APPLICABLE REQUIREMENTS OF THE 2018 INTERNATIONAL BUILDING CODE, THE 2018 INTERNATIONAL ENERGY CONSERVATION CODE, THE 2018 INTERNATIONAL PLUMBING CODE, THE 2018 INTERNATIONAL MECHANICAL CODE, THE 2017 NATIONAL ELECTRIC CODE, AS WELL AS ALL LOCAL & GREEN AMENDMENTS. CONTRACTOR SHALL OBTAIN ALL LICENSES AND PERMITS REQUIRED BY THE JURISDICTION WITH AUTHORITY OVER THE

CONSTRUCTION OF THIS PROJECT. ALL DIMENSIONS ARE TO FACE OF CONCRETE, BRICK, WOOD FRAMING OR CENTERLINE OF STRUCTURAL LINES, UNLESS NOTED OTHERWISE. ALL WINDOW HEAD HEIGHTS ARE TO ADJACENT FINISH FLOOR. ALL INTERIOR DOORS TO BE LOCATED 5" OFF ADJACENT WALL UNLESS

OTHERWISE NOTED. ALL EXTERIOR AND INTERIOR MATERIALS AND FINISHES SHALL BE AS SHOWN IN THE ARCHITECTURAL & INTERIOR DRAWINGS OR AS NEGOTIATED BY THE OWNER & CONTRACTOR FOR ITEMS NOT DETAILED.

CONTRACTOR SHALL REVIEW THE DRAWINGS FOR THIS PROJECT, AND VERIFY ALL EXISTING CONDITIONS, FIELD DIMENSIONS, AND OTHER ASPECTS OF THIS PROJECT PRIOR TO BEGINNING CONSTRUCTION. NOTIFY OWNER OR ARCHITECT OF ANY DISCREPANCIES.

THE EXISTING CONDITIONS DEPICTED ON THESE DRAWINGS ARE BASED ON THE BEST AVAILABLE INFORMATION AND SHALL BE VERIFIED BY THE CONTRACTOR PRIOR TO CONSTRUCTION.

REFER TO MECHANICAL, PLUMBING & ELECTRICAL DRAWINGS FOR ADDITIONAL INFORMATION. USE ONLY APPROVED, NON-EXPANSIVE, GRANULAR MATERIAL AS FILL.

ALL FILL MATERIAL TO BE APPROVED BY OWNER. ALL MATERIALS TO BE INSTALLED PER MANUFACTURERS SPECIFICIATIONS UNLESS OTHERWISE NOTED.

# PROJECT TEAM

TENANT: Frameworks Timber 208 Raquette Drive, Unit F Fort Collins, CO 80524 Contact: Pete Grant phone: 970-568-4900 email: pete@frameworkstimber.com

**GENERAL CONTRACTOR:** 

ARCHITECT: Studio S Architecture, LLC 715 W. Mountain Avenue Fort Collins, CO 80521 Contact: Heidi Shuff phone: 970-231-1040 email: heidi@studio-s-arch.com

INTERIOR DESIGNER: K Squared Design Fort Collins, CO Contact: Kathryn Kurtz phone: 970-420-5209

email: kathryn@k-squareddesign.com

MECHANICAL/ PLUMBING DESIGN: Integrated Mechanical, LLC 223 Linden Street, Suite 204 Fort Collins, CO 80524 Contact: Ginnie Schofield

email: ginnie-s@int-mech.com ELECTRICAL DESIGN: Gust Engineering 2621 Rigden Farms Parkway, Suite C5

phone: 970-556-0570


Fort Collins, CO 80525 Contact: Mike Gust phone: 970-482-1776 email: mgust@gustengineering.com Frameworks Timber 3 Old Town Square Fort Collins, Colorado

No.	Description	Date	
	ISSUED FOR PERMIT	3.12.21	

COVER SHEET, PROJECT **INFORMATION & EXTERIOR IMPROVEMENTS** 

**Project Number** Project number 03.12.21 HMS Drawn by HMS Checked by

A0.1

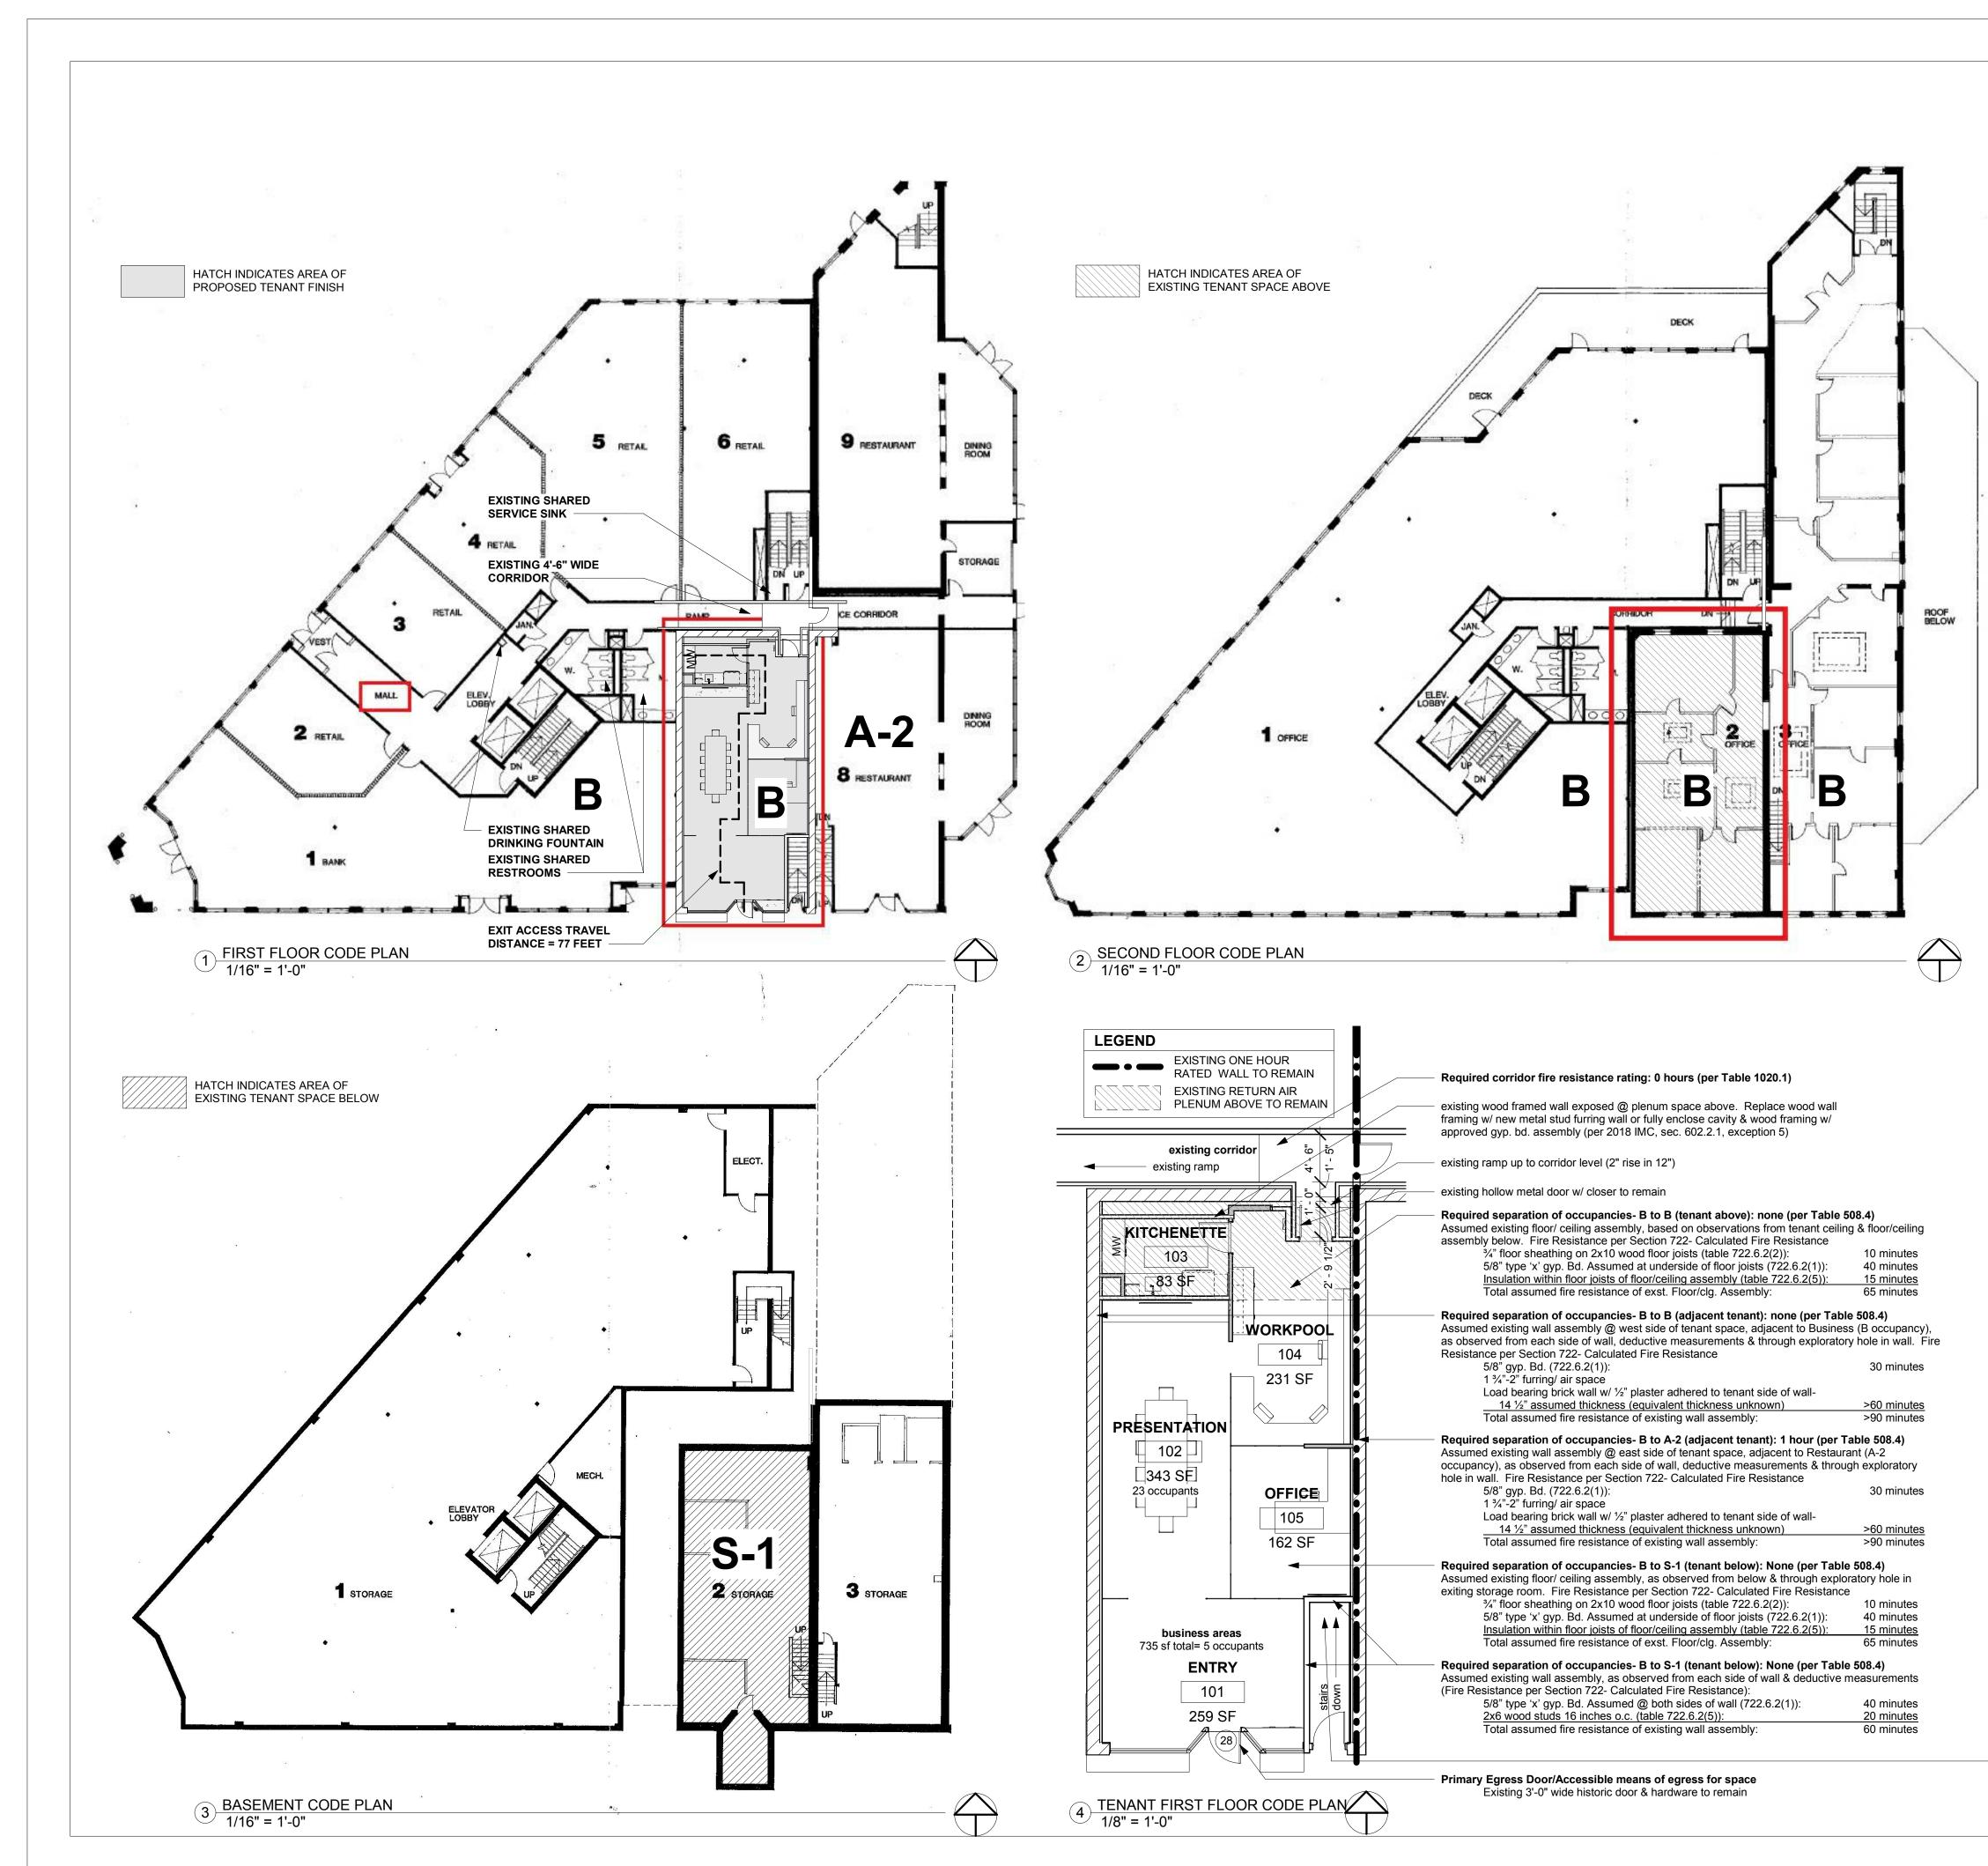

## CODE ANALYSIS

#### Tenant Area: 1,092 SF

Note: Tenant area & surrounding building is fully sprinkled (NFPA 13 sprinkler system assumed)

### Occupancy Classification:

Previous: Mercantile Group M (309.1)

Proposed: Business Group B (304.1)

·Per 303.1.2 Small assembly spaces: A room or space used for assembly purposes that is less than 750 SF in area and accessory to another occupancy shall be classified as Group B occupancy or as part of that occupancy.

## Mixed use and occupancy:

Required separation of occupancies (Table 508.4)
B to S-2 (to basement tenant space): 1 hour

B to A-2 (to adjacent tenant space to east): 1 hour
B to B (to adjacent tenant spaces to west & above): no separation requirement

### Occupant Load (per table 1004.5):

·60 gross for retail area (960 SF)= 16 occupants ·300 gross for storage area (132 SF)= 1 occupant ·Total: 17 occupants

·150 gross for business areas (735 SF)= 5 occupants ·15 SF/person for conference room (343 SF)= 23 occupants ·Total: 28 occupants

#### leans of Egress

Ceiling height- the means of egress shall have a ceiling height of not less than 7'-6" above the finished floor (1003.2)

Egress from spaces- one exit required per Table 1006.2.1
Occupancy- B, maximum occupant load of space- 49 (actual = 28), maximum common path of egress travel distance (with sprinkler system)- 100 feet (actual =

Accessible means of egress- one accessible means of egress required (1009.1)

·Size of doors- 32" minimum clear opening width (1010.1.1)
·Door swing- egress doors shall be of the pivoted or side-hinged swinging type

Exception 1.- private office areas with an occupant load of 10 or less Direction of swing- not required to swing in the direction of egress travel, as the occupant load is less than 50 (1010.1.2.1)

Door opening force- the force for pushing or pulling open interior swinging egress doors, other than fire doors, shall not exceed 5 pounds (1010.1.3)
Floor elevation- variations in elevation due to difference in finish materials, up to ½" elevation difference, is allowed at each side of a door (1010.1.5, exception 4)
Thresholds- thresholds at doorways shall not exceed ½" in height above the finished floor or landing. Raised thresholds and floor level changes greater than ¼" at doorways shall be beveled with a slope not greater than one unit vertical in two units horizontal (50% slope) (1010.1.7)

Egress through intervening spaces can be provided when such adjoining rooms or areas and the area served are accessory to one or the other, are not a Group H occupancy and provide a discernible path of egress travel to an exit (1016.2,

exception 2)
Exit Access Travel Distance- 300' (per Table 1017.2)

Required fire resistance rating = 0 hours (per table 1020.1)
Use of the space between the corridor ceiling and the floor or roof structure above as a return air plenum is permitted if the corridor is not required to be of fire-resistance-rated construction (1020.5.1.1)

## Accessibility

Exit Access-

Accessible Entrances- At least one accessible entrance shall be provided to each tenant in a facility (1105.1.6)

# Plumbing Fixture Requirements (per table 2902.1) Previous- Mercantile, 18 occupants

·Water Closets- Male (9): 1 per 500 = 1
·Water Closets- Female (9): 1 per 500 = 1
·Lavatories- Male (9): 1 per 750 = 1
·Lavatories- Female (9): 1 per 750 = 1
·Drinking fountains (18): 1 per 1,000 = 1
·Service Sink: 1

Proposed- Business, 28 occupants:
·Water Closets- Male (14): 1 per 25 for the first 50 = 1
·Water Closets- Female (14): 1 per 25 for the first 50 = 1
·Lavatories- Male (14): 1 per 40 for the first 80 = 1
·Lavatories- Female (14): 1 per 40 for the first 80 = 1
·Drinking fountains (28): 1 per 100 = 1
·Service Sink: 1

Shared facilities provided for building via corridor to north:

·Water Closets- Male: 3

·Water Closets- Female: 3

·Lavatories- Male: 2

·Lavatories- Male: 2 · Drinking fountains: 1

·Service Sink: 1

urn Air nlenum

Return Air plenum
-Existing return air plenum to remain above proposed kitchenette & hall @ north end of tenant space (between existing gyp. bd. drop ceiling & existing gyp. bd. ceiling @ underside

of floor joists above)
-Plenum enclosure construction materials that are exposed to the airflow shall comply with the requirements of Section 703.5 of the Interionational Building Code or such materials shall have a flame spread index of not more than 25 and a smoke-developed index of not more than 50 when tested in accordance with ASTM E84 or UL 723
-Plenum construction & materials within plenum space to comply with 2018 IMC, section 602.2

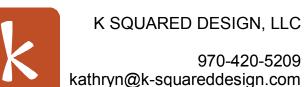


 photo looking north from existing stairway east of proposed tenant space, illustrating evidence of use of type 'x' gypsum board



715 w. mountain avenue fort collins, colorado 80521

phone: 970.231.1040 e-mail: heidi@studio-s-arch.com





Frameworks Timber
3 Old Town Square
Fort Collins, Colorado

No.	Description	Date
	ISSUED FOR PERMIT	3.12.21

CODE PLANS & CODE ANALYSIS

Project number	Project Number
Date	03.12.21
Drawn by	HMS
Checked by	HMS

A1.0





D1 REMOVE WALLS AS INDICATED BY DASHED LINE, REVIEW WITH STRUCTURAL ENGINEER PRIOR TO REMOVAL

D2 REMOVE DOOR AND FRAME

 $\langle D3 \rangle$  REMOVE EXISTING SHELVING

REMOVE BULKHEAD (IF POSSIBLE)

REMOVE OVERHEAD LIGHTING

STRIP ADJACENT TO BUILDING AND PREP FOR REPLACEMENT

> FRAMEWORKS OFFICE #3 OLD TOWN SQUARE #3

K SQUARED DESIGN, LLC space planning - interior design 1032 valley view road fort collins, CO kathryn@k-squareddesign.com (970) 420-5209

PRELIM: 01/25/21


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REV. #:

REV. DATE:

11.1



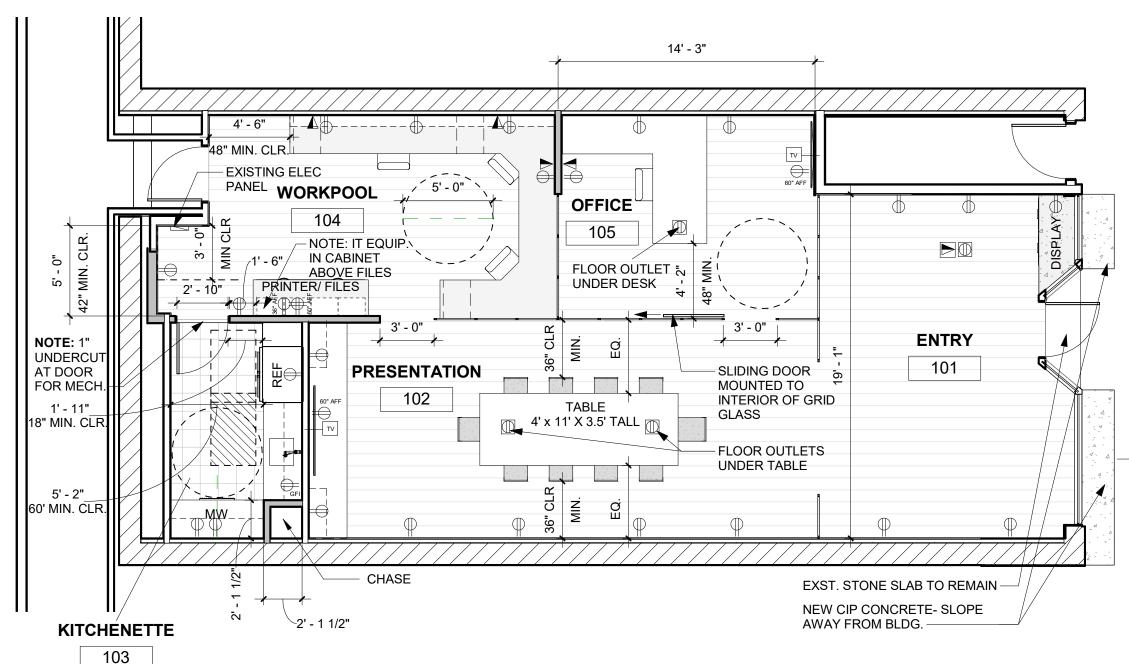

# Z NEW FIRST FLOOR PLAN 3/16" = 1'-0"

#### **GENERAL NOTES:**

- 1. ALL CONSTRUCTION SHALL BE IN ACCORDANCE OF CURRENT CODES AND LOCAL ADMENDMENTS.
  CONTRACTOR SHALL OBTAIN ALL LICENSES AND PERMITS REQUIRED BY THE JURISDICTION WITH AUTHORITY OVER THE CONSTRUCTION OF THIS PROJECT.
- 2. ALL WALLS TO BE REMOVED TO BE VERIFIED BY STRUCTURAL ENGINEER PRIOR TO REMOVAL.
- 3. CONTRACTOR SHALL REVIEW THE DRAWINGS FOR THIS PROJECT AND VERIFY ALL EXISTING CONDITIONS, FIELD DIMENSIONS AND OTHER ASPECTS PRIOR TO BEGINNING CONSTRUCTION. NOTIFY OWNER OF ANY DISCREPANCIES.
- 4. MECHANICAL, ELECTRICAL AND PLUMBING SHALL BE DESIGN/ BUILD BY SELECTED SUBCONTRACOR
- 5. THE EXISTING CONDITIONS DEPICTED IN THESE DRAWINGS ARE BASED ON THE BEST AVAILABLE INFORMATION AND SHALL BE VERIFIED BY THE CONTRACTOR PRIOR TO CONSTRUCTION.
- 6. DIMENSIONS ARE TO FINISH (IF EXISTING) AND FRAMING (IF NEW), UNLESS NOTED OTHERWISE.

#### **ELECTRICAL LEGEND:**

 $\bigoplus_{\mathsf{GFI}} \mathsf{DUPLEX}\,\mathsf{RECEPTACLE}$ 

SINGLE POLE SWITCH

\$3 THREE-WAY SWITCH

TV

FLOOR OUTLET

DATA, WALL MOUNTED

DATA, FLOOR MOUNTED

\_\_\_\_\_

#### **ELECTRICAL NOTES:**

- 1. THIS ELECTRICAL PLAN IS TO SERVE AS A DESIGN GUIDELINE ONLY. ALL ELECTRICAL WORK IS TO CONFORM TO THE CURRENT ELECTRICAL CODE W/ LOCAL AMENDMENTS.
- 2. CONTRACTOR TO ARRANGE WALK-THRU W/ OWNER AFTER FRAMING IS COMPLETED TO FIELD LOCATE ALL DEVICES & FIXTURES.
- 3. CONTRACTOR TO REVIEW EQUIPMENT SPECIFICATIONS AND VERIFY POWER NEEDS
- 4. ONLY OUTLETS FOR SPECIFIC USE HAVE BEEN INDICATED. ALL OTHER OUTLETS TO BE DETERMINED BY CODE AND DURING OWNER WALK-THROUGH.
  5. COORDINATE ALL FIXTURE & DEVICE SELECTIONS W/ THE OWNER.



space planning - interior design 1032 valley view road fort collins, CO kathryn@k-squareddesign.com (970) 420-5209


FRAMEWORKS OFFICE #3 OLD TOWN SQUARE


PRELIM: 02/22/21
PERMIT: 03/12/21

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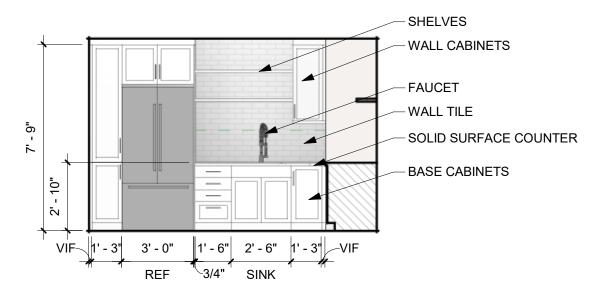
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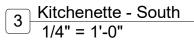
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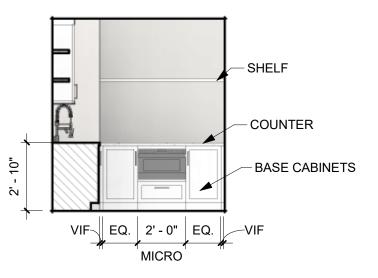




Kitchenette - East 1/4" = 1'-0"

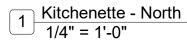

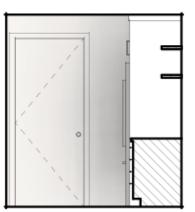



Kitchenette - West
1/4" = 1'-0"


PRELIM: 01/25/21

PERMIT: 03/12/21

REV. #:

REV. DATE:

**15.1** 

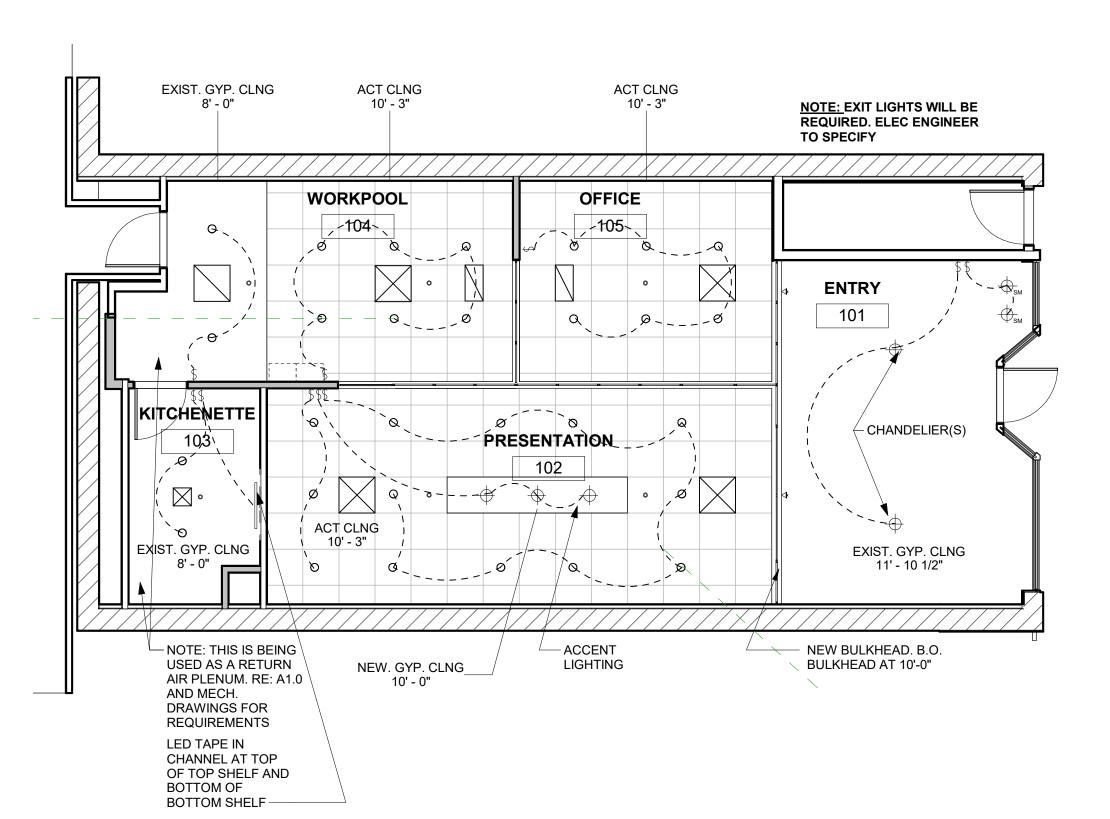

#### LIGHTING/ HVAC LEGEND:

PENDANT FIXTURE

SURFACE MTD. FIXTURE

WALL MTD. FIXTURE

RECESSED CAN FIXTURE

SUPPLY



RETURN



UNDER CABINET FIXTURE

- **CONCEALED FIRE** 0 SPRINKLER HEAD
- HORIZONTAL SIDEWALL FIRE SPRINKLER HEAD

#### **ELECTRICAL NOTES:**

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- 2. CONTRACTOR TO ARRANGE WALK-THRU W/ OWNER AFTER FRAMING IS COMPLETED TO FIELD LOCATE ALL DEVICES & FIXTURES.
- 3. CONTRACTOR TO REVIEW **EQUIPMENT SPECIFICATIONS AND VERIFY POWER NEEDS**
- 4. ONLY OUTLETS FOR SPECIFIC USE HAVE BEEN INDICATED. ALL OTHER OUTLETS TO BE DETERMINED BY CODE AND DURING OWNER WALK-THROUGH.
- 5. COORDINATE ALL FIXTURE & DEVICE SELECTIONS W/ THE OWNER.



K SQUARED DESIGN, LLC space planning - interior design 1032 valley view road fort collins, CO kathryn@k-squareddesign.com (970) 420-5209

ШШ SQUAR OFFIC **FRAMEWORKS** TOWN OLD

PRELIM:

PERMIT: 03/12/21

#3

02/22/21

REV. #:

REV. DATE:

16.1

FIRST FLOOR - REFLECTED CEILING PLAN 3/16" = 1'-0"

# GENERAL MECHANICAL REQUIREMENTS:

#### CODES AND PERMITS

WORK SHALL BE PERFORMED IN ACCORDANCE WITH ALL APPLICABLE STATE AND LOCAL CODES, REGULATIONS AND ORDINANCES. PERMITS NECESSARY FOR PERFORMANCE OF WORK SHALL BE SECURED AND PAID FOR BY THE CONTRACTOR. DRAWINGS AND COORDINATION

DRAWINGS FOR MECHANICAL WORK ARE DIAGRAMMATIC IN NATURE, AND ARE NOT INTENDED TO BE SCALED FOR EXACT MEASUREMENTS NOR TO SERVE AS SHOP DRAWINGS. CHANGES FROM THE PLANS MADE WITHOUT CONSENT OF THE ENGINEER SHALL RELIEVE THE ENGINEER OF RESPONSIBILITY FOR ALL CONSEQUENCES ARRIVING OUT OF SUCH CHANGES. INSTALLATION SHALL BE IN ACCORDANCE WITH MANUFACTURER'S INSTALLATION INSTRUCTIONS. WHERE CONDITIONS REQUIRE REASONABLE CHANGES TO THOSE INDICATED ON THE DRAWINGS, MAKE SUCH CHANGES WITHOUT ADDITIONAL COST TO THE OWNER. COORDINATE ALL WORK WITH OTHER TRADES.

#### WARRANTY

WORKMANSHIP, MATERIALS, EQUIPMENT AND PROPER OPERATION SHALL BE GUARANTEED FOR A PERIOD OF ONE YEAR FROM THE DATE OF FINAL ACCEPTANCE FROM THE OWNER. INITIAL ACCEPTANCE OF WORK SHALL NOT WAIVE THIS GUARANTEE. THIS GUARANTEE SHALL NOT INCLUDE NORMAL MAINTENANCE REQUIRED BY THE OWNER AS DESCRIBED IN EQUIPMENT OPERATION AND MAINTENANCE MANUALS.

# SUBMITTALS

CONTRACTOR SHALL SUBMIT TO THE ARCHITECT/ENGINEER A MINIMUM OF (5) COPIES OF SUBMITTAL BROCHURES FOR REVIEW. PROVIDE INFORMATION ON ALL MAJOR EQUIPMENT AS LISTED ON DRAWING EQUIPMENT SCHEDULES, AS WELL AS VALVES. DUCTWORK ACCESSORIES AND TEMPERATURE CONTROL DIAGRAMS AS APPLICABLE.

#### OPERATION AND MAINTENANCE MANUALS

CONTRACTOR SHALL FURNISH AT THE COMPLETION OF THE PROJECT (2) COPIES OF COMPLETE OPERATION AND MAINTENANCE MANUALS TO THE ARCHITECT/ENGINEER FOR REVIEW PRIOR TO TURNOVER TO OWNER. MANUALS TO BE BOUND AND INCLUDE INSTALLATION INSTRUCTIONS, REPLACEMENT PARTS LISTS AND MAINTENANCE INFORMATION ON ALL EQUIPMENT AS DESCRIBED IN THE SUBMITTALS SECTION. COMPLETED OPERATION AND MAINTENANCE MANUALS ARE TO BE FORWARDED TO THE OWNER WITHIN 90 DAYS AFTER OWNER BUILDING ACCEPTANCE.

MANUFACTURER MODEL NUMBERS LISTED ON THE DRAWINGS AND/OR SPECIFICATIONS ARE TO BE CONSIDERED AS THE BASIS OF DESIGN. WHERE TWO OR MORE ALTERNATE MANUFACTURERS OR MATERIALS ARE LISTED. THE CHOICE OF THESE SHALL BE OPTIONAL WITH THE CONTRACTOR. PRIOR TO THE AWARDING OF THE CONTRACT, CONTRACTOR MAY REQUEST A PROPOSED SUBSTITUTION OF MATERIALS IN WRITING TO THE ARCHITECT/ENGINEER NO LATER THAN SEVEN DAYS PRIOR TO THE RECEIPT OF BIDS. THE COST OF ANY CHANGES REQUIRED BY OTHER TRADES. INCLUDING A/E DESIGN. DUE TO THE USE OF EQUIPMENT AND/OR MATERIALS OTHER THAN THAT OF THE BASIS OF DESIGN SHALL BE PAID BY THE CONTRACTOR.

CONTRACTORS SHALL MAINTAIN A COMPLETE AND ACCURATE SET OF MARKED UP DRAWINGS SHOWING ACTUAL LOCATIONS OF INSTALLED WORK. THESE DRAWINGS ARE TO BE FORWARDED TO THE OWNER AS PART OF THE OPERATION AND MAINTENANCE MANUALS AT THE COMPLETION OF THE PROJECT

PROVIDE ALL ACCESS DOORS/PANELS AS REQUIRED FOR ACCESS TO VALVES, DAMPERS, CONTROL DEVICES, FILTERS AND ANY OTHER ITEMS FOR WHICH ACCESS IS REQUIRED FOR EITHER OPERATION OR SERVICING. WHERE ACCESS DOORS ARE TO BE INSTALLED IN ASSEMBLIES REQUIRED TO HAVE A SPECIFIC FIRE RATING, ACCESS DOORS SHALL ALSO BE FIRE RATED.

#### PIPING AND DUCTWORK SEALANT THROUGH RATED ASSEMBLIES

PENETRATIONS SHALL BE SEALED AS REQUIRED IN ACCORDANCE WITH BUILDING AND MECHANICAL CODES TO RESIST THE PASSAGE OF FLAME AND PRODUCTS OF COMBUSTION IN ORDER TO MAINTAIN THE RESISTANCE RATING OF THE CONSTRUCTION BEING PENETRATED.

## PROTECTION OF MATERIALS AND EQUIPMENT

CONTRACTOR SHALL BE RESPONSIBLE FOR PROTECTION OF ALL WORK, MATERALS, AND EQUIPMENT PROVIDED UNDER THIS SECTION. PIPE OPENINGS SHALL BE CLOSED WITH CAPS OR PLUGS TO PREVENT THE ENTRANCE OF DEBRIS DURING CONSTRUCTION. ALL DUCTWORK OPENINGS SHALL BE SEALED CLOSED DURING CONSTRUCTION.

# EQUIPMENT AND PIPING IDENTIFICATION

PROVIDE EQUIPMENT LABELS FOR ALL MAJOR EQUIPMENT, INCLUDING BUT NOT LIMITED TO AIR HANDLING SYSTEMS, FANS, VAV BOXES, CONTROLS, DAMPERS, CONTROL VALVES AND PUMPS.

PROVIDE PIPE MARKERS ON CW, HW AND HWC SYSTEMS. LABELS TO BE AT MAXIMUM 8 FEET APART, WITH FLOW DIRECTION INDICATED, AS APPLICABLE.

ADDITIONALLY, PROVIDE LABELING ON POTABLE WATER MANIFOLDS INDICATING PLUMBING FIXTURE SERVED BY THE OUTLET, AS APPLICABLE. LABELS SHALL BE AFFIXED OR ADHERED PERMANENTLY TO EQUIPMENT. EQUIPMENT INSTALLED INDOORS TO BE LABELED

WITH EMBOSSING TAPE.

EQUIPMENT INSTALLED OUTDOORS TO BE LABELED WITH ENGRAVED PLASTIC LAMINATE SIGNS. PIPE MARKERS TO BE SELF-ADHESIVE, MANUFACTURED FOR SUCH PURPOSE.

# STARTERS AND DISCONNECTS

EQUIPMENT STARTERS SHALL BE FURNISHED BY THE MECHANICAL CONTRACTOR AND INSTALLED BY THE ELECTRICAL CONTRACTOR. EQUIPMENT DISCONNECTS SHALL BE PROVIDED BY THE ELECTRICAL CONTRACTOR UNLESS NOTED OTHERWISE ON THE DRAWINGS. STARTERS SHALL BE NEMA TYPE, AND SHALL INCLUDE PHASE MONITORING FOR MOTORS 5 HP AND LARGER.

TESTING SHALL BE PERFORMED ON THE FOLLOWING SYSTEMS SPECIFIED. ALL SYSTEMS LISTED MAY NOT BE INCLUDED IN PROJECT, REFER TO DRAWINGS FOR APPLICABLE SYSTEMS.

SOIL, WASTE AND STORM DRAINAGE PIPING SHALL BE TESTED IN ACCORDANCE WITH APPLICABLE STATE AND LOCAL CODES. DOMESTIC WATER PIPING SHALL BE TESTED AND PROVEN WATERTIGHT UNDER A PRESSURE NOT LESS THAN THE WORKING PRESSURE OF THE SYSTEM FOR A 24 HOUR PERIOD.

DOMESTIC WATER PIPING SYSTEM SHALL BE CHLORINATED AND STERILIZED IN ACCORDANCE WITH REQUIREMENTS OF LOCAL

NATURAL GAS PIPING SHALL BE TESTED WITH AN AIR PRESSURE OF MINIMUM TWO TIMES THE DESIGN SYSTEM PRESSURE, BUT NO LESS THAN 3 PSIG, FOR A PERIOD OF 24 HOURS WITHOUT PRESSURE DROP.

# **BALANCING**

SYSTEM BALANCING SHALL BE PERFORMED BY A CERTIFIED BALANCING CONTRACTOR. BALANCE ALL SYSTEMS INCLUDING AIRFLOW TO AND FROM ALL OPENINGS, AND PUMPED WATER SYSTEMS INCLUDING DOMESTIC WATER RECIRCULATION SYSTEMS AS APPLICABLE. MAKE ANY ADJUSTMENTS NECESSARY TO RESULT IN CONDITIONS INDICATED AND PROVIDE READJUSTMENTS TO ITEMS IN REPORT AS MAY BE REQUESTED BY ARCHITECT/ENGINEER. SUBMIT TWO COPIES OF TEST AND BALANCE REPORT FOR APPROVAL. FAN AND PUMP SYSTEMS TO BE BALANCED WITHIN PLUS OR MINUS 5 PERCENT OF LISTED VALUES. AIR INLETS AND OUTLETS TO BE BALANCED WITHIN PLUS 10 PERCENT OR MINUS 5 PERCENT OF LISTED VALUES. BALANCE REPORT TO INCLUDE:

UNIT IDENTIFICATION

MANUFACTURER AND NAMEPLATE DATA EQUIPMENT NAMEPLATE AMPERAGE AND ACTUAL AMPERAGE

RPM (DESIGN AND ACTUAL)

FAN CFM (DESIGN AND ACTUAL) FAN STATIC PRESSURE (DESIGN AND ACTUAL)

REGISTER, GRILLE, DIFFUSER REFERENCE NUMBER AND LOCATION

INLET/OUTLET CFM (DESIGN AND ACTUAL)

FLOW DEVICE PRESSURE DROP, CFM OR GPM A FINAL BALANCING REPORT SHALL BE PROVIDED TO THE OWNER AFTER COMPLETION OF THE PROJECT.

CLEANING AT THE COMPLETION OF WORK, ALL FIXTURES AND EQUIPMENT SHALL BE THOROUGHLY CLEANED AND DELIVERED IN A CONDITION SATISFACTORY TO THE ARCHITECT. ALL FILTERS SHALL BE REPLACED WITH NEW PRIOR TO OWNER ACCEPTANCE OF THE BUILDING.

# HVAC LEGEND:

RECT DUCT (NEW SHADED/EXISTING UNSHADED)

ROUND DUCT (NEW SHADED/EXISTING UNSHADED)

RECT DUCT SIZE CHANGE

RECT DUCT CHANGE TO ROUND

RECT ELBOW UP (SUPPLY)

RECT ELBOW UP (NON-SUPPLY)

RECT ELBOW DOWN (SUPPLY)

RECT ELBOW DOWN (NON-SUPPLY)

ROUND ELBOW UP

ROUND ELBOW DOWN RECT ELBOW W/ TURNING VANES

ROUND ELBOW

ROUND TAKE-OFF W/ DAMPER FROM RECT MAIN ROUND TAKE-OFF W/ DAMPER FROM ROUND MAIN

RECT TAKE-OFF W/ DAMPER FROM RECT MAIN RECT TAKE-OFF W/ DAMPER FROM ROUND MAIN

DIFFUSER WITH FLEX DUCT

RETURN GRILLE (UNDUCTED)

RETURN/EXHAUST GRILLE (DUCTED)

AIRFLOW PATTERNS

THERMOSTAT WITH ZONE TAG

SENSOR WITH ZONE TAG

CARBON DIOXIDE SENSOR

FIRE DAMPER TAG

FIRE/SMOKE DAMPER WITH DUCT DETECTOR

SMOKE DAMPER WITH DUCT DETECTOR

DUCT WITH VOLUME DAMPER

DUCT WITH MOTORIZED DAMPER

DUCT WITH COUNTERBALANCED DAMPER HVAC SCOPE TO BE REMOVED

----- RS ----- REFRIGERANT SUCTION

—— LP —— REFRIGERANT LOW PRESSURE

# CITY OF FORT COLLINS GREEN CODE REQUIREMENTS

- BEFORE OCCUPANCY AND AFTER ALL INTERIOR FINISHES ARE COMPLETE, THE BUILDING IS TO BE FLUSHED OUT (VENTILATED) FOR A PERIOD OF 14 DAYS. WHERE CONTINUOUS VENTILATION IS NOT POSSIBLE, THE AGGREGATE OF FLUSH-OUT PERIODS SHALL BE EQUIVALENT TO 14 DAYS. CONTRACTOR SHALL PROVIDE FLUSH-OUT REPORTS TO THE BUILDING OFFICIAL UPON COMPLETION OF WORK. CONTRACTOR TO COORDINATE WITH BUILDING OFFICIAL FOR INFORMATION TO BE CONTAINED IN FLUSH-OUT REPORTS.
- PROTECT HVAC EQUIPMENT FROM CONSTRUCTION DUST AND DEBRIS. DO NOT OPERATE HVAC EQUIPMENT DURING CONSTRUCTION AND SEAL ALL DUCT OPENINGS WITH PLASTIC.
- LOW-VOLATILE ORGANIC COMPOUND (VOC) DUCT INSULATION ADHESIVE SHALL BE USED: DESIGN POLYMERICS 2501, 2502 OR APPROVED EQUAL.
- LOW-VOLATILE ORGANIC COMPOUND (VOC) DUCT SEALANT SHALL BE USED: DESIGN POLYMERICS 1010, 1015 OR APPROVED EQUAL.

LOW-VOLATILE ORGANIC COMPOUND (VOC) FIRE CAULK

SHALL BE USED: 3M FIRE BARRIER 1C 15WB+, FD 150+, CP 25WB+ OR APPROVED EQUAL. A CONSTRUCTION WASTE MANAGEMENT PLAN WILL BE IMPLEMENTED REQUIRING RECYCLING OF NONHAZARDOUS CONSTRUCTION DEBRIS. COORDINATE WITH G.C. FOR

RECYCLING OF ITEMS RELATED TO THE MECHANICAL

SCOPE OF WORK.

# INSULATION NOTES AND HVAC ENERGY CODE

GENERAL HVAC NOTES

APPLICABLE CODES.

2" PRESSURE CLASS.

INSULATED SUB-BASE.

- THE MECHANICAL DESIGN IS BASED ON THE 2018 INTERNATIONAL ENERGY CONSERVATION CODE.
- ALL SUPPLY, RETURN AND EXHAUST DUCTWORK SHALL BE SEALED AIRTIGHT WITH DUCT SEALANT ALONG ALL SEAMS AND

MECHANICAL WORK SHALL COMPLY WITH ALL APPLICABLE

ON THE 2018 INTERNATIONAL MECHANICAL CODE.

THE SIZE OF SHEET METAL ACCORDINGLY.

CODES. VERIFY ALL REQUIREMENTS PRIOR TO SUBMITTING BID

OR COMMENCING WORK. THE MECHANICAL DESIGN IS BASED

ALL DUCTWORK SHALL BE CONSTRUCTED OF GALVANIZED SHEET

THE CURRENT EDITION OF SMACNA OR AS REQUIRED BY ALL

CONSTRUCT ALL SUPPLY AND RETURN DUCTWORK TO SMACNA

DIMENSIONS OF DUCTWORK SHOWN INDICATES CLEAR INSIDE

UNLESS NOTED OTHERWISE, THE SIZE OF THE BRANCH DUCT

SERVING A SINGLE DIFFUSER SHALL BE THE SAME AS THE

NECK SIZE OF THE DIFFUSER SERVED. FLEXIBLE DUCTWORK

SHALL NOT EXCEED 8'-0" IN LENGTH. FLEXIBLE DUCTWORK

SHALL BE UL181 LISTED WITH 50/25 SMOKE/FLAME RATING, CONSISTING OF POLYESTER FILM ENCAPSULATING AN INNER

CORROSION RESISTANT STEEL WIRE HELIX CORE. FLEXIBLE

WITH FOIL SCRIM FILM VAPOR BARRIER JACKET, R-6.

WALL MOUNTED THERMOSTATS AND SENSORS SHALL BE

INSTALLED 48" ABOVE FINISHED FLOOR UNLESS NOTED

OTHERWISE. THERMOSTATS AND SENSORS LOCATED ON

BE 7-DAY PROGRAMMABLE TYPE, 4 PERIODS PER DAY,

10-HOUR BATTERY BACK-UP, 2-HOUR OVERRIDE, 5 DEG

DEAD-BAND, HEAT/COOL/OFF/AUTO CHANGEOVER, AUTO

EXTERIOR WALL SURFACES SHALL BE PROVIDED WITH AN

THERMOSTATS FOR COOLING AND HEATING EQUIPMENT SHALL

SETBACK TO 55 DEG F (HEAT) AND 85 DEG F (COOL), LCD

TEMPORARY HEATING: THE PERMANENT HVAC SYSTEM MAY

COMPLETED AND HAS BEEN PAINTED. IF THE PERMANENT

INTAKES SHALL BE COVERED WITH FILTER MEDIA (MERV-8 RATING). IF EXCESSIVE DUST OR DEBRIS HAS ENTERED THE

SYSTEM THEN ALL COIL AND DUCT SURFACES SHALL BE

BE THE RESPONSIBILITY OF THE G.C.

NOT BE UTILIZED FOR HEATING UNTIL ALL GYPSUM WORK IS

HVAC SYSTEM IS UTILIZED DURING CONSTRUCTION, ALL DUCT

CLEANED. NEW FILTERS ARE TO BE PROVIDED JUST PRIOR TO

TURNOVER TO OWNER. TEMPORARY HEATING OF THE BUILDING

FIELD FABRICATED TO MATCH CORRESPONDING EQUIPMENT. THE

PROVIDE AND INSTALL SYSTEM(S) INCLUDING ALL COMPONENTS

NECESSARY FOR A FULL AND COMPLETE. OPERATIONAL SYSTEM.

THIS INCLUDES, BUT IS NOT LIMITED TO: LOW VOLTAGE WIRING,

VOLTAGE INTERFACING SHALL BE COORDINATED DIRECTLY WITH

PRIOR TO ANY USE OF THE PERMANENT HVAC SYSTEM SHALL

TEMPERATURE CONTROLS SHALL BE DESIGN BUILD, CUSTOM,

COMPONENTS. THE CONTRACTOR SHALL PROPERLY SELECT,

SYSTEM SHALL UTILIZE STAND ALONE ELECTRONIC

THERMOSTATS, DAMPER MOTORS, SOLENOIDS, RELAYS.

CONTACTORS, STARTERS, TIME CLOCKS, CONTROL PANELS,

SYSTEM COMMISSIONING AND OWNER TRAINING. ALL LINE

THE ELECTRICAL CONTRACTOR. PROVIDE SUBMITTALS ON

COMPONENTS AND WIRING DIAGRAMS PRIOR TO ORDERING

BACKLIT DISPLAY, HARD WIRED POWER, HARD WIRED CONTROL.

DUCT SHALL INCLUDE AN EXTERIOR FIBERGLASS INSULATION

DIMENSIONS - WHERE DUCT LINER IS TO BE ADDED, INCREASE

METAL - CONSTRUCTION AND INSTALLATION SHALL CONFORM TO


SEE HVAC INSULATION SCHEDULE FOR DUCT INSULATION REQUIREMENTS.

# architecture

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# FRAMEWORKS TIMBER

3 OLD TOWN SQUARE FORT COLLINS, CO


No.	Description	Date
	ISSUED FOR PERMIT	03.12.21
1 1		
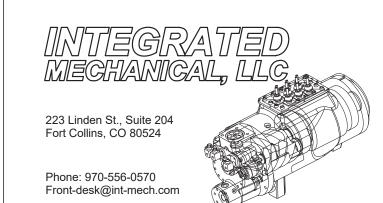
# MECHANICAL DRAWING INDEX

NUMBER SHEET NAME HO.1 HVAC NOTES, LEGEND & INDEX H2.1 HVAC PLAN. SCHEDULES & DETAILS **HVAC NOTES, LEGEND & INDEX** 


21-023 Project number 03-12-2021 GJS Drawn by GMG Checked by

H0.1

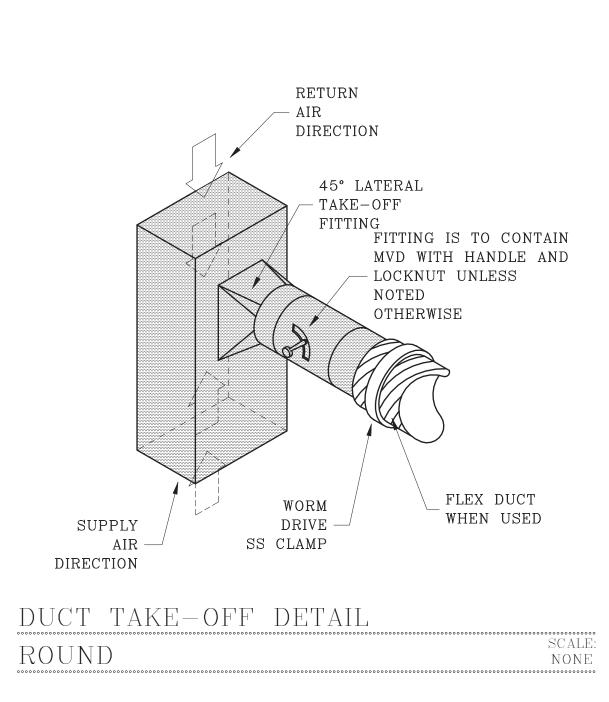

# FLAG NOTES:

- 1 COMPLETELY REMOVE (E) SIDEWALL SA GRILLES FROM THE (E) DUCT MAIN. PATCH AND SEAL DUCT OPENING AIRTIGHT.
- (2) COMPLETELY REMOVE (E) ROUND SA DIFFUSERS AND ALL ASSOCIATED DUCTWORK AT THIS LOCATION. PROVIDE NEW HIGH EFFICIENCY TAKE-OFF W/DAMPER, DUCTWORK AND DIFFUSER, SIZED AS INDICATED, REUSING (E) DUCT OPENING.
- (3) PROVIDE NEW DUCT EXTENSION, ROUTE ABOVE NEW CEILING. ATTACH NEW SIDEWALL REGISTERS THROUGH BULKHEAD, SIZED AS INDICATED. COORDINATE FINAL INSTALLATION HEIGHT AND LOCATION ALONG BULKHEAD WITH (E) BUILDING STRUCTURE AND ALL ASSOCIATED COMPONENTS.
- (4) COMPLETELY REMOVE (E) SIDEWALL RA GRILLE ABOVE STORAGE ROOM DOOR. PROVIDE NEW RA GRILLE, SIZE AS INDICATED MOUNTED IN CEILING. EXTEND DUCTWORK FROM GRILLE THROUGH (E) WALL OPENING, INTO PLENUM SPACE ABOVE CEILING OF NEW KITCHENETTE SPACE. OFFSET AND TRANSITION DUCTWORK AS REQUIRED TO PASS THROUGH (E) WALL OPENING.
- (5) ATTACH LINED 22"x10" SHEETMETAL PLENUM TO EACH TRANSFER GRILLE, CONNECT WITH 8"Ø FLEX DUCT TO PLENUM WITH HIGH EFFICIENCY TAKE OFF FITTING WITHOUT DAMPER.
- (6) (E) SA DUCTWORK, ABOVE CEILING, CONTINUED FROM (E) PINCH DOWN BOX AND AHU TO REMAIN AS IS UNLESS OTHERWISE NOTED.

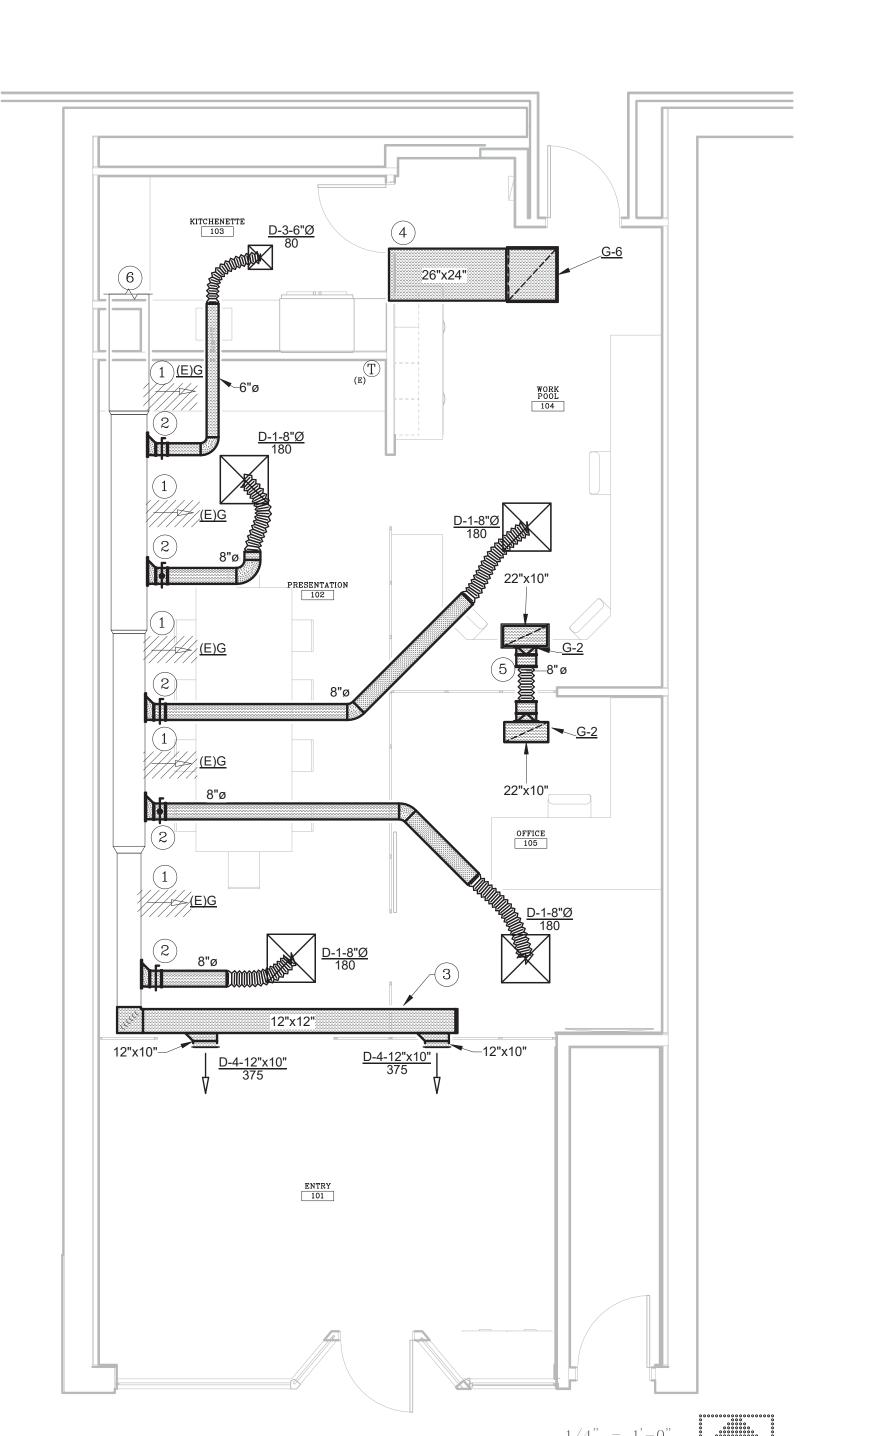

HVAC FLOOR PLAN




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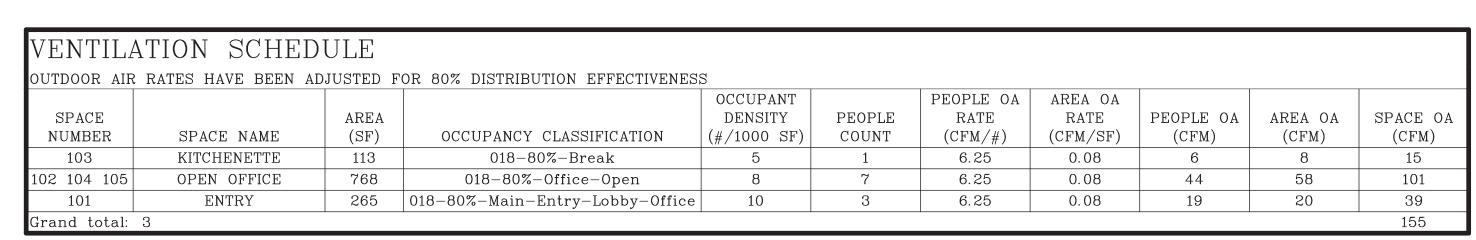
3 OLD TOWN SQUARE FORT COLLINS, CO

No.	Description	Date
	ISSUED FOR PERMIT	03.12.21

HVAC PLAN, SCHEDULES & **DETAILS** 

Project number	21-023
Date	03-12-2021
Drawn by	GJS
Checked by	GMG

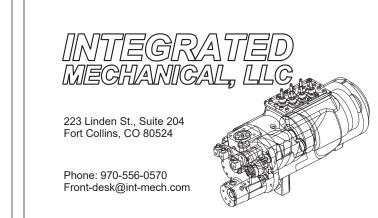H2.1



NOTE: EXISTING AHU VENTILATION RATED ASSUMED TO BE 20% PER STANDARD PRACTICES.

- TOTAL SUPPLY AIR VOLUME = 1,550 CFM / 20% OSA = 310 CFM OUTSIDE AIR PROVIDED

GRII	GRILLES, REGISTERS AND DIFFUSERS SCHEDULE										
			NECK				FRAME	FRAME	FRAME		
TAG	MAKE & MODEL NUMBER	DESCRIPTION	SIZE	COUNT	DUTY	COLOR	SIZE	TYPE	CONST	DAMPER	REMARKS
D-1	TITUS OMNI-3	ARCHITECTURAL UNI-FLO DIFFUSER	8"ø	4	SUPPLY	BLACK	24"x24"	LAY-IN	STEEL	NO	
D-3	TITUS OMNI-1	ARCHITECTURAL UNI-FLO DIFFUSER	6"ø	1	SUPPLY	PRIMED	12"x12"	SURFACE	STEEL	YES	WITH TRIM FRAME
D-4	TITUS 300RL-1	SIDEWALL SUPPLY DIFFUSER	12"x10"	2	SUPPLY	PRIMED	NECK +2	SIDEWALL	STEEL	YES	
G-2	TITUS PAR-3	PERFORATED FACE GRILLE	22"x10"	2	RETURN	BLACK	24"x12"	LAY-IN	STEEL	NO	
G-6	TITUS 350RL	LOUVERED FACE GRILLE	24"x26"	1	RETURN	PRIMED	NECK +1.75"	SURFACE	STEEL	NO	

INSULATION THICKNESS DENSITY TOTAL						
KEY	INSULATION DESCRIPTION	TYPE	(IN)	(PCF)	VALUE	(NRC)
H01	RECTANGULAR DUCT IN CEILING SPACE WITH NO ROOF	LINER	1.0	1.5	4.2	0.70
H02	RECTANGULAR DUCT IN CEILING SPACE ADJACENT TO EXTERIOR ROOF	LINER	1.5	1.5	6.0	0.80
H03	RECTANGULAR DUCT IN CEILING SPACE ADJACENT TO EXTERIOR ROOF AND SPACE IS A RETURN PLENUM	LINER	1.0	1.5	4.2	0.70
H04	FLEXIBLE DUCT TO DIFFUSER	FLEX	1.5	~	6.0	~
H05	ROUND DUCT IN CEILING SPACE WITH NO ROOF	WRAP	1.5	0.75	4.2	~
H06	ROUND DUCT IN SPACE ADJACENT TO EXTERIOR ROOF	WRAP	2.1	0.75	6.0	~
H07	RECTANGULAR DUCT EXTERIOR TO BUILDING ENVELOPE. DOUBLE WALL WATER TIGHT CONSTRUCTION. WRAP NOT ACCEPTABLE	LINER	3.0	1.5	12	0.95
H08	ROUND DUCT EXPOSED IN CONDITIONED SPACE	N/R		~	~	~
H09	RECTANGULAR DUCT EXPOSED IN CONDITIONED SPACE	LINER	1.0	1.5	4.2	0.70
H10	ROUND OR RECTANGULAR OUTSIDE AIR DUCT	WRAP	5.0	0.75	12	~
H11	ROUND DUCT IN VENTILATED CRAWL SPACE	WRAP	5.0	0.75	12	~
H12	RECTANGULAR DUCT IN VENTILATED CRAWL SPACE	LINER	3.0	1.5	12	0.95
H13	BURIED ROUND DUCT	INTERNAL		~	6.0	~

PIPE SUPPORT SCHEDULE					
PIPING MATERIAL	MAX HORIZ SPACING	MAX VERT SPACING			
ABS PLASTIC < 2.5"	4 FEET	5 FEET			
ABS PLASTIC > 2"	4 FEET	10 FEET			
ALUMINUM COMPRESSED AIR	8 FEET	10 FEET			
CAST-IRON < 10 FOOT SEGMENTS	5 FEET	15 FEET			
CAST-IRON 10 FOOT SEGMENTS	10 FEET	15 FEET			
CPVC < 1.25"	3 FEET	5 FEET			
CPVC > 1" AND < 2.5"	4 FEET	5 FEET			
CPVC > 2"	4 FEET	10 FEET			
COPPER < 1.5"	6 FEET	10 FEET			
COPPER > 1.25"	10 FEET	10 FEET			
PEX < 2.5"	32 INCHES	5 FEET			
PEX > 2"	32 INCHES	10 FEET			
PVC < 2.5"	4 FEET	5 FEET			
PVC > 2"	4 FEET	10 FEET			
STEEL	12 FEET	15 FEET			

# GENERAL PLUMBING NOTES

- 1 PLUMBING WORK SHALL COMPLY WITH ALL APPLICABLE CODES. VERIFY ALL REQUIREMENTS PRIOR TO SUBMITTING BID OR COMMENCING WORK. THE PLUMBING DESIGN IS BASED ON THE 2018 INTERNATIONAL PLUMBING CODE.
- WASTE AND VENT PIPING BELOW SLAB SHALL BE SCHEDULE 40, DWV, PVC, PLASTIC. FITTINGS SHALL BE PVC.
- WASTE AND VENT PIPING ABOVE SLAB (NOT IN RETURN AIR PLENUM) SHALL BE SCHEDULE 40, DWV, PVC, PLASTIC. FITTINGS SHALL BE PVC.
- POTABLE WATER PIPING 2" AND SMALLER SHALL BE PEX-A TUBING MANUFACTURED BY UPONOR/WIRSBO OR APPROVED EQUAL. FITTINGS SHALL BE EXPANSION TYPE WITH SECONDARY EXPANSION RING (NOT CRIMPED). CW SHALL BE RUN IN BLUE PIPE, HW & HWC IN RED, OTHER SYSTEMS CLEAR. PIPING SHALL BE PROPERLY SUPPORTED USING PLENUM RATED GALVANIZED TROUGHS OR CHANNELS HUNG AT MAXIMUM 8' INTERVALS. UNSUPPORTED PEX MAY NOT EXCEED 32".
- POTABLE WATER VALVES SHALL BE FULL PORT, BALL TYPE.
- HANGERS FOR 2" AND SMALLER PIPE SHALL BE BAND TYPE, 2.5" AND LARGER SHALL BE CLEVIS TYPE. USE COPPER COATED TYPE ON COPPER PIPE.
- INSTALL FULL SIZE CONDENSATE AND TRAP FOR ALL COOLING COILS. DISCHARGE FULL SIZE DRAIN TO MOP SINK OR LAVATORY P-TRAP TAILPIECE AND TO ROOF FOR ROOFTOP UNITS.

# GENERAL MECHANICAL REQUIREMENTS:

### CODES AND PERMITS

WORK SHALL BE PERFORMED IN ACCORDANCE WITH ALL APPLICABLE STATE AND LOCAL CODES. REGULATIONS AND ORDINANCES. PERMITS NECESSARY FOR PERFORMANCE OF WORK SHALL BE SECURED AND PAID FOR BY THE CONTRACTOR. DRAWINGS AND COORDINATION

DRAWINGS FOR MECHANICAL WORK ARE DIAGRAMMATIC IN NATURE, AND ARE NOT INTENDED TO BE SCALED FOR EXACT MEASUREMENTS NOR TO SERVE AS SHOP DRAWINGS. CHANGES FROM THE PLANS MADE WITHOUT CONSENT OF THE ENGINEER SHALL RELIEVE THE ENGINEER OF RESPONSIBILITY FOR ALL CONSEQUENCES ARRIVING OUT OF SUCH CHANGES. INSTALLATION SHALL BE IN ACCORDANCE WITH MANUFACTURER'S INSTALLATION INSTRUCTIONS. WHERE CONDITIONS REQUIRE REASONABLE CHANGES TO THOSE INDICATED ON THE DRAWINGS. MAKE SUCH CHANGES WITHOUT ADDITIONAL COST TO THE OWNER. COORDINATE ALL WORK WITH OTHER TRADES.

## WARRANTY

WORKMANSHIP, MATERIALS, EQUIPMENT AND PROPER OPERATION SHALL BE GUARANTEED FOR A PERIOD OF ONE YEAR FROM THE DATE OF FINAL ACCEPTANCE FROM THE OWNER. INITIAL ACCEPTANCE OF WORK SHALL NOT WAIVE THIS GUARANTEE. THIS GUARANTEE SHALL NOT INCLUDE NORMAL MAINTENANCE REQUIRED BY THE OWNER AS DESCRIBED IN EQUIPMENT OPERATION AND MAINTENANCE MANUALS.

#### SUBMITTALS CONTRACTOR SHALL SUBMIT TO THE ARCHITECT/ENGINEER A MINIMUM OF (5) COPIES OF SUBMITTAL BROCHURES FOR REVIEW. PROVIDE INFORMATION ON ALL MAJOR EQUIPMENT AS LISTED ON DRAWING EQUIPMENT SCHEDULES, AS WELL AS VALVES, DUCTWORK ACCESSORIES AND TEMPERATURE CONTROL DIAGRAMS AS APPLICABLE.

## OPERATION AND MAINTENANCE MANUALS

CONTRACTOR SHALL FURNISH AT THE COMPLETION OF THE PROJECT (2) COPIES OF COMPLETE OPERATION AND MAINTENANCE MANUALS TO THE ARCHITECT/ENGINEER FOR REVIEW PRIOR TO TURNOVER TO OWNER. MANUALS TO BE BOUND AND INCLUDE INSTALLATION INSTRUCTIONS, REPLACEMENT PARTS LISTS AND MAINTENANCE INFORMATION ON ALL EQUIPMENT AS DESCRIBED IN THE SUBMITTALS SECTION. COMPLETED OPERATION AND MAINTENANCE MANUALS ARE TO BE FORWARDED TO THE OWNER WITHIN 90 DAYS AFTER OWNER BUILDING ACCEPTANCE.

### PRODUCT SUBSTITUTIONS

MANUFACTURER MODEL NUMBERS LISTED ON THE DRAWINGS AND/OR SPECIFICATIONS ARE TO BE CONSIDERED AS THE BASIS OF DESIGN. WHERE TWO OR MORE ALTERNATE MANUFACTURERS OR MATERIALS ARE LISTED, THE CHOICE OF THESE SHALL BE OPTIONAL WITH THE CONTRACTOR. PRIOR TO THE AWARDING OF THE CONTRACT, CONTRACTOR MAY REQUEST A PROPOSED SUBSTITUTION OF MATERIALS IN WRITING TO THE ARCHITECT/ENGINEER NO LATER THAN SEVEN DAYS PRIOR TO THE RECEIPT OF BIDS. THE COST OF ANY CHANGES REQUIRED BY OTHER TRADES, INCLUDING A/E DESIGN, DUE TO THE USE OF EQUIPMENT AND/OR MATERIALS OTHER THAN THAT OF THE BASIS OF DESIGN SHALL BE PAID BY THE CONTRACTOR.

#### RECORD DRAWINGS

CONTRACTORS SHALL MAINTAIN A COMPLETE AND ACCURATE SET OF MARKED UP DRAWINGS SHOWING ACTUAL LOCATIONS OF INSTALLED WORK. THESE DRAWINGS ARE TO BE FORWARDED TO THE OWNER AS PART OF THE OPERATION AND MAINTENANCE MANUALS AT THE COMPLETION OF THE PROJECT.

### ACCESS DOORS

PROVIDE ALL ACCESS DOORS/PANELS AS REQUIRED FOR ACCESS TO VALVES, DAMPERS, CONTROL DEVICES, FILTERS AND ANY OTHER ITEMS FOR WHICH ACCESS IS REQUIRED FOR EITHER OPERATION OR SERVICING. WHERE ACCESS DOORS ARE TO BE INSTALLED IN ASSEMBLIES REQUIRED TO HAVE A SPECIFIC FIRE RATING, ACCESS DOORS SHALL ALSO BE FIRE

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#### CONSTRUCTION BEING PENETRATED. PROTECTION OF MATERIALS AND EQUIPMENT

CONTRACTOR SHALL BE RESPONSIBLE FOR PROTECTION OF ALL WORK, MATERALS, AND EQUIPMENT PROVIDED UNDER THIS SECTION. PIPE OPENINGS SHALL BE CLOSED WITH CAPS OR PLUGS TO PREVENT THE ENTRANCE OF DEBRIS DURING CONSTRUCTION. ALL DUCTWORK OPENINGS SHALL BE SEALED CLOSED DURING CONSTRUCTION.

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PROVIDE PIPE MARKERS ON CW. HW AND HWC SYSTEMS. LABELS TO BE AT MAXIMUM 8 FEET APART. WITH FLOW DIRECTION INDICATED, AS APPLICABLE.

ADDITIONALLY, PROVIDE LABELING ON POTABLE WATER MANIFOLDS INDICATING PLUMBING FIXTURE SERVED BY THE OUTLET. AS APPLICABLE.

LABELS SHALL BE AFFIXED OR ADHERED PERMANENTLY TO EQUIPMENT. EQUIPMENT INSTALLED INDOORS TO BE LABELED WITH EMBOSSING TAPE.

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EQUIPMENT STARTERS SHALL BE FURNISHED BY THE MECHANICAL CONTRACTOR AND INSTALLED BY THE ELECTRICAL CONTRACTOR. EQUIPMENT DISCONNECTS SHALL BE PROVIDED BY THE ELECTRICAL CONTRACTOR UNLESS NOTED OTHERWISE ON THE DRAWINGS. STARTERS SHALL BE NEMA TYPE, AND SHALL INCLUDE PHASE MONITORING FOR MOTORS 5 HP AND

**TESTING** TESTING SHALL BE PERFORMED ON THE FOLLOWING SYSTEMS SPECIFIED. ALL SYSTEMS LISTED MAY NOT BE INCLUDED IN

PROJECT, REFER TO DRAWINGS FOR APPLICABLE SYSTEMS. SOIL, WASTE AND STORM DRAINAGE PIPING SHALL BE TESTED IN ACCORDANCE WITH APPLICABLE STATE AND LOCAL CODES. DOMESTIC WATER PIPING SHALL BE TESTED AND PROVEN WATERTIGHT UNDER A PRESSURE NOT LESS THAN THE WORKING PRESSURE OF THE SYSTEM FOR A 24 HOUR PERIOD.

DOMESTIC WATER PIPING SYSTEM SHALL BE CHLORINATED AND STERILIZED IN ACCORDANCE WITH REQUIREMENTS OF LOCAL

NATURAL GAS PIPING SHALL BE TESTED WITH AN AIR PRESSURE OF MINIMUM TWO TIMES THE DESIGN SYSTEM PRESSURE, BUT NO LESS THAN 3 PSIG, FOR A PERIOD OF 24 HOURS WITHOUT PRESSURE DROP.

SYSTEM BALANCING SHALL BE PERFORMED BY A CERTIFIED BALANCING CONTRACTOR. BALANCE ALL SYSTEMS INCLUDING AIRFLOW TO AND FROM ALL OPENINGS, AND PUMPED WATER SYSTEMS INCLUDING DOMESTIC WATER RECIRCULATION SYSTEMS AS APPLICABLE. MAKE ANY ADJUSTMENTS NECESSARY TO RESULT IN CONDITIONS INDICATED AND PROVIDE READJUSTMENTS TO ITEMS IN REPORT AS MAY BE REQUESTED BY ARCHITECT/ENGINEER. SUBMIT TWO COPIES OF TEST AND BALANCE REPORT FOR APPROVAL. FAN AND PUMP SYSTEMS TO BE BALANCED WITHIN PLUS OR MINUS 5 PERCENT OF LISTED VALUES. AIR INLETS AND OUTLETS TO BE BALANCED WITHIN PLUS 10 PERCENT OR MINUS 5 PERCENT OF LISTED VALUES. BALANCE REPORT TO INCLUDE:

# UNIT IDENTIFICATION

MANUFACTURER AND NAMEPLATE DATA EQUIPMENT NAMEPLATE AMPERAGE AND ACTUAL AMPERAGE

RPM (DESIGN AND ACTUAL)

FAN CFM (DESIGN AND ACTUAL)

FAN STATIC PRESSURE (DESIGN AND ACTUAL)

REGISTER, GRILLE, DIFFUSER REFERENCE NUMBER AND LOCATION

INLET/OUTLET CFM (DESIGN AND ACTUAL)

FLOW DEVICE PRESSURE DROP. CFM OR GPM

A FINAL BALANCING REPORT SHALL BE PROVIDED TO THE OWNER AFTER COMPLETION OF THE PROJECT. CLEANING

AT THE COMPLETION OF WORK, ALL FIXTURES AND EQUIPMENT SHALL BE THOROUGHLY CLEANED AND DELIVERED IN A CONDITION SATISFACTORY TO THE ARCHITECT. ALL FILTERS SHALL BE REPLACED WITH NEW PRIOR TO OWNER ACCEPTANCE OF THE BUILDING.

# INSULATION NOTES AND

PLUMBING LEGEND:

V—VV—VENT PIPING

-----W------ WASTE PIPING

FIRE PIPING

——LP—— PROPANE PIPING

——CA—— COMP AIR PIPING

PIPE ELBOW DOWN

PIPE ELBOW UP

——VAC—— VACUUM PIPING

PIPE TEE UP

X

SHT #

SHEET

NUMBER SHEET NAME

PIPE TEE DOWN

DETAIL X

SHEET #

DETAIL

PLUMBING DRAWING INDEX

P2.1 PLUMBING FLOOR PLANS & DETAILS

PO.1 PLUMBING NOTES, LEGEND, SCHEDULES & INDEX

REFERENCE

OR ISOMETRIC

- 1 THE MECHANICAL DESIGN IS BASED ON THE 2018 INTERNATIONAL ENERGY CONSERVATION CODE.
- 2 HOT WATER PIPING SHALL BE INSULATED USING FIBERGLASS INSULATION WITH ALL SERVICE JACKET HAVING MAXIMUM 'K' FACTOR OF 0.27. INSULATION THICKNESS SHALL BE 1".
- 3 COLD WATER PIPING SHALL BE INSULATED USING FIBERGLASS INSULATION WITH ALL SERVICE JACKET HAVING MAXIMUM 'K' FACTOR OF 0.27. INSULATION THICKNESS SHALL BE 0.5". DO NOT REMOVE THIS ITEM FROM THE PROJECT AS IT IS REQUIRED FOR CONDENSATE CONTROL.

——CW—— COLD WATER PIPING ————— BALL VALVE

——HW—— HOT WATER PIPING ——─────── GATE VALVE

——TW—— TEMPERED WATER ——─── PRESS. RED. VALVE

——GW—— GREASE WASTE PIPING———♦ BALANCE VALVE

**—** 

——CD—— CONDENSATE PIPING ——— CHECK VALVE

——G—— NATURAL GAS PIPING——∥—— UNION

T & P RELIEF VALVE

PIPE CONTINUATION

SOLENOID VALVE

PIPE CAP

——ORD—— OVERFLOW RD PIPE

ROOF DRAIN

FLOOR CLEANOUT

GRADE CLEANOUT

WALL CLEANOUT

INVERT ELEVATION

////Ø//// PIPE TO BE REMOVED

EXISTING

RELOCATE

NEW

——HWC—— HOT WATER CIRC. ——√—— GAS COCK

# PLUMBING ENERGY CODE


715 w. mountain avenue

phone: 970.231.1040 e-mail: heidi@studio-s-arch.com

fort collins, colorado 80521

s t u d i o S



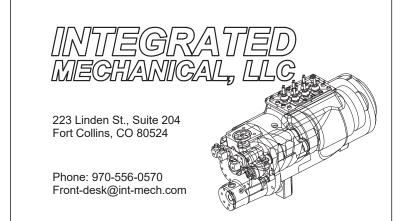



# FRAMEWORKS TIMBER

3 OLD TOWN SQUARE FORT COLLINS, CO


No.	Description	Date
	ISSUED FOR PERMIT	03.12.21


# PLUMBING NOTES, LEGEND, SCHEDULES & INDEX

Project number	21-023
Date	03-12-2021
Drawn by	GJS
Checked by	GMG

P0.1


FIXTURE ROUGH-IN SCHEDULE							
FIXTURE TYPE	COLD WATER	HOT WATER					
SINK	0.5"	0.5"					
REFRIGERATOR BOX (ICE)	0.5"	_					

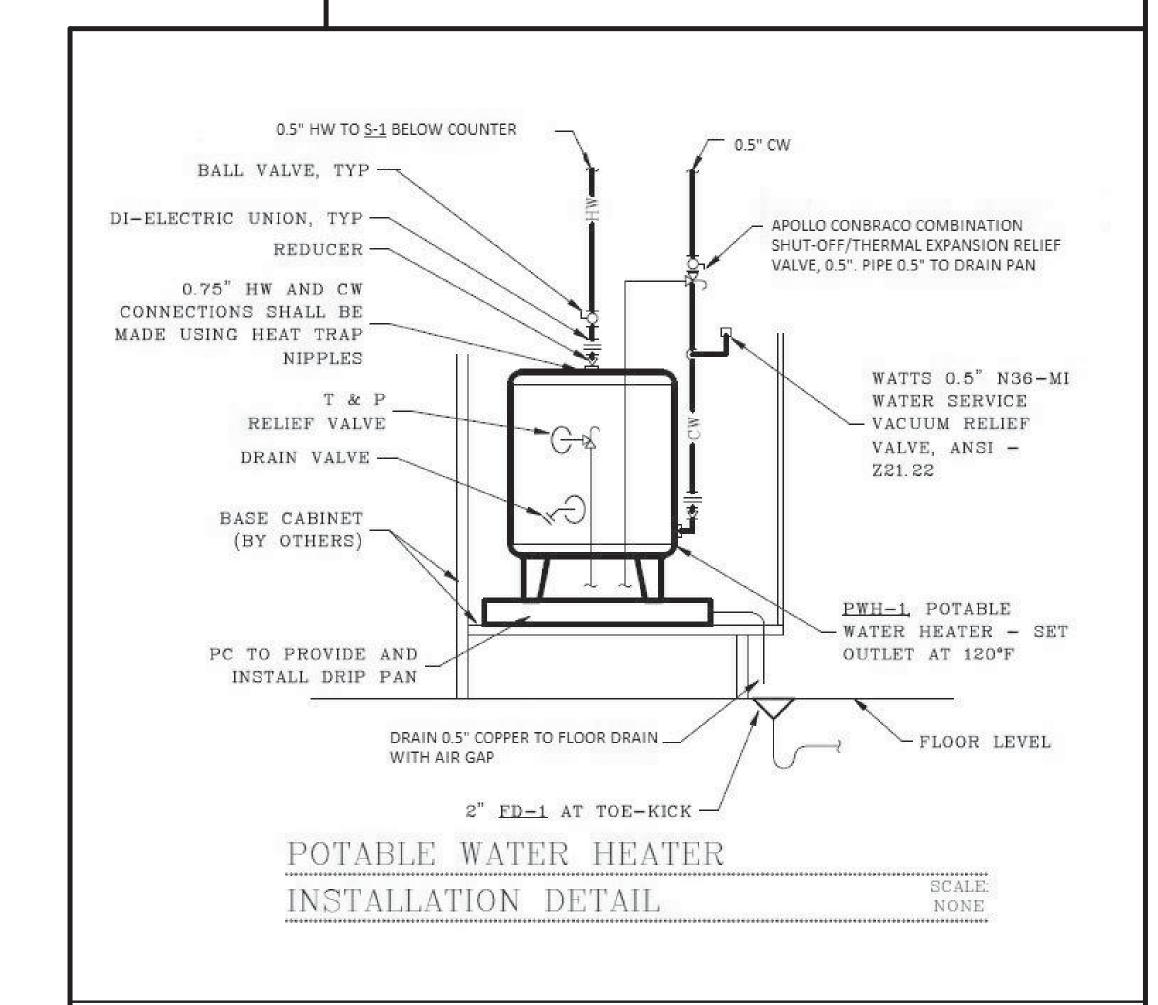

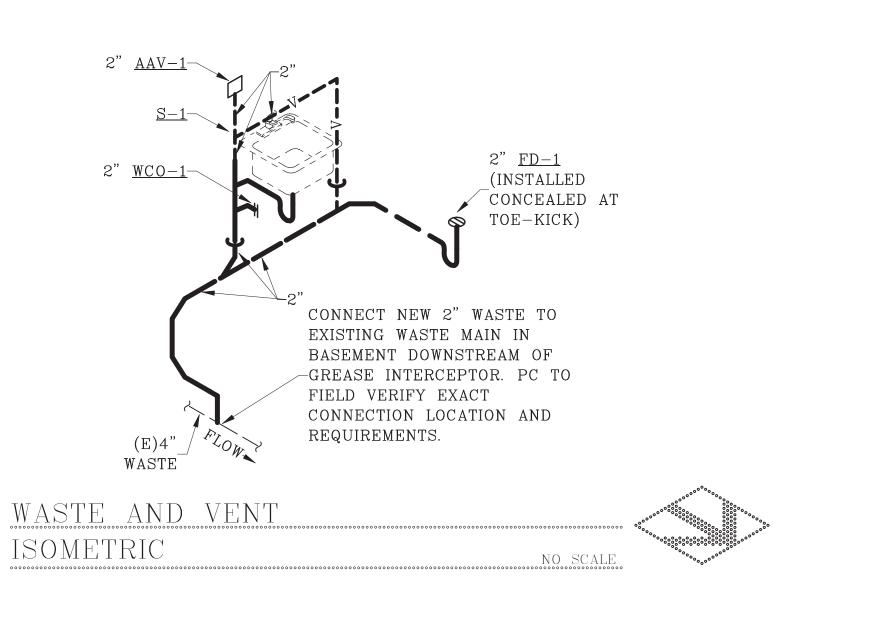

# FLAG NOTES:

- 1 ROUTE NEW 2" WASTE FROM KITCHENETTE DOWN TO WITHIN BASEMENT. CONNECT TO EXISTING WASTE LINE DOWNSTREAM OF EXISTING GREASE INTERCEPTOR. REFER TO WASTE AND VENT ISOMETRIC ON THIS SHEET. CONTRACTOR SHALL FIELD VERIFY CONNECTION REQUIREMENTS AND COORDINATE SCOPE OF WORK IN NEIGHBORING TENANT SPACE WITH GC.
- CONNECT NEW 0.75" CW PIPING TO (E) BUILDING CW PIPING FROM THE RESTROOM GROUP TO THE WEST OF THE KITCHENETTE. FIELD VERIFY AND COORDINATE CONNECTION LOCATION.
- 3 0.5" CW ROUTED DOWN IN WALL AND INTO CASEWORK TO SERVE <u>PWH-1</u>, <u>S-1</u> AND <u>RB-1</u>. ROUTE 0.5" CW TO <u>PWH-1</u> MOUNTED WITHIN CASEWORK AND REFER TO <u>FIXTURE ROUGH-IN SCHEDULE</u> ON THIS SHEET FOR ADDITIONAL INFORMATION.
- PWH-1 MOUNTED WITHIN CASEWORK. REFER TO <u>POTABLE</u>
  WATER HEATER INSTALLATION DETAIL ON THIS SHEET FOR
  ADDITIONAL INFORMATION.

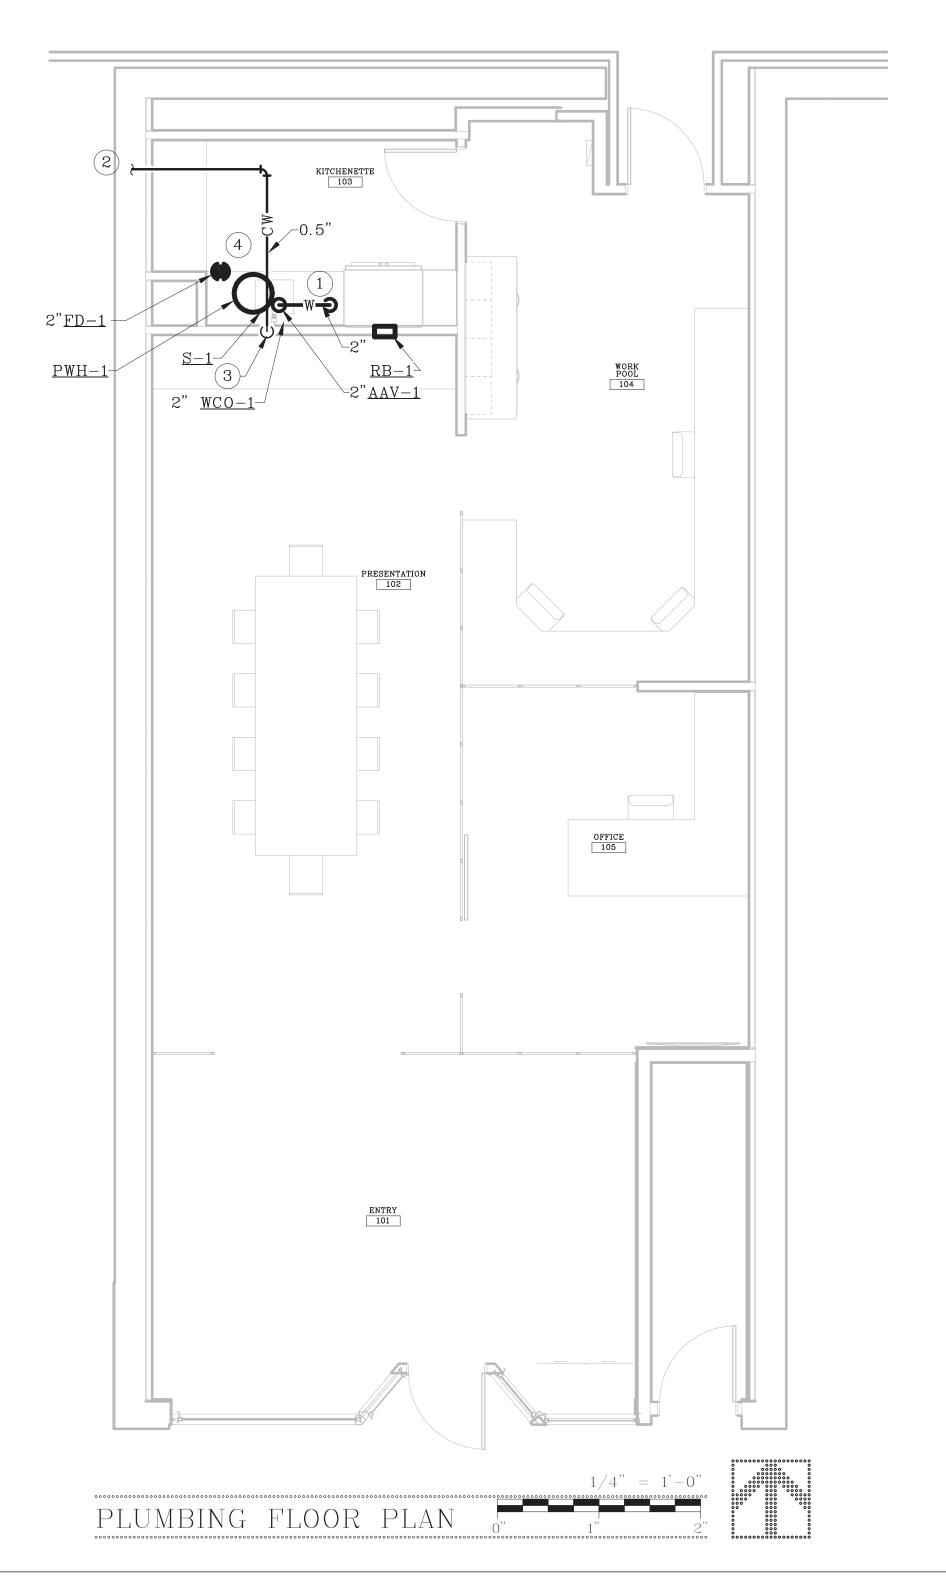




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K SQUARED DESIGN, LLC 970-420-5209 kathryn@k-squareddesign.com



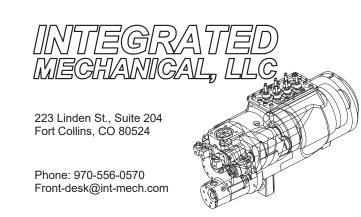

# FRAMEWORKS TIMBER

3 OLD TOWN SQUARE FORT COLLINS, CO

No.	Description	Date
	ISSUED FOR PERMIT	03.12.21

# PLUMBING FLOOR PLANS & DETAILS

Project number	21-023
Date	03-12-2021
Drawn by	GJS
Checked by	GMG

P2.1

	ELECTRICAL FIXTURE SCHEDULE								
Type Mark	Count	Manufacturer	Model	Description					
R1	20	HUBBELL	HBL5362	NEMA 5-20R RECEPTACLE, MOUNT AT 1'6" AFF					
R2	2	HUBBELL	GF20	NEMA 5-20R, GFCI RECEPTACLE, ABOVE COUNTER					
R3 1 HUBBELL HBL5362 DUPLEX RECEPTACLE FOR REFRIGERATOR, MOUNT AT 30" AFF. PROVIDE GFCI BREAKER									
R4	3	HUBBELL	HBL5362	BL5362 NEMA 5-20R RECEPTACLE, MOUNT ABOVE COUNTER					
R5	2	HUBBELL	HBL5362	NEMA 5-20R RECEPTACLE, MOUNT AT TV HEIGHT					
R6	2	HUBBELL	HBL5362	NEMA 5-20R RECEPTACLE, MOUNT FOR WINDOW DISPLAYS					
R7	1	HUBBELL	GF20	NEMA 5-20R GFCI RECEPTACLE, MOUNT FOR EXTERIOR SIGN, PROVIDE WEATHERPROOF COVER					
R8	1	HUBBELL	TWO - HBL5362	TWO NEMA 5-20R RECEPTACLES					
R9	4	LEGRAND	LEGEND RFB4	RECTANGULAR FLOOR BOX - 2 DUPLEX RECEPTACLES AND 4 JACK LOCATIONS. RUN 1" CONDUIT WITH PULL STRING TO ABOVE ACCESSABLE CEILING					
R10	1	HUBBELL	HBL5362	NEMA 5-20R RECEPTACLE FOR MICROWAVE, MOUNT IN MICROWAVE CABINET					
Grand total: 37	1	1	1	'					

LIGHTING DEVICE SCHEDULE									
Type Mark	Count	Manufacturer	Model	Description					
CM 7 LEGRAND DT-355 DUAL TECHNOLOGY LINE VOLTAGE CEILING MOUNT OCCUPANCY SENSOR									
S1	9	LEGRAND	RH703PTUTC	120 VOLT LINE VOLTAGE DIMMER, 450 WATT MAXIMUM, VERIFY LIGHT FIXTURE COMPATIBILITY					
S2	1	LEGRAND	RH4FBL3PTC	WALLBOX DIMMER SWITCH WITH 0-10V DIMMING. VERIFY LIGHT FIXTURE COMPATIBILITY					

#### Grand total: 17

	LIGHTING FIXTURE SCHEDULE								
Type Mark	Count	Manufacturer	Model	Description					
Α	31	COOPER	H750ICAT/LT560WH12930	6" RECEDDED CAN, 1140 LUMEN, 30K, WHITE REFLECTOR AND TRIM, 11.9 WATTS					
В	3	OWNER PROVIDED	OWNER PROVIDED	OWNER PROVIDED LED PENDANT NOT TO EXCEED 150 WATTS					
С	2	OWNER PROVIDED	OWNER PROVIDED	OWNER PROVIDED LED PENDANT NOT TO EXCEED 150 WATTS					
D	1	BEULUX	AA02-SL-A-L460-CT27-EC-MC- LENGTH + AA99-CL	RIBBON LIGHT, 460 LUMENS/FT, 2700K, 4.1 WATTS/FT, 120 VOLT, 0-10 VOLT DIMMING DRIVER, IN DOORS, EXTUSION MOUNT WITH SATINED LENS, LENGHT AS SHOWN, MOUNTING CLIPS, END CAP, # WATTS					
ER	1	DUAL LITE	EVOD	TWO LED OUTDOOR REMOTE EMERGENCY LIGHTING HEADS					
EW	2	DUAL LITE	EVCUGWD4I	ILLUMINATED EXIT SIGN, WALL MOUNT, GREEN LETTERS ON WHITE BACKGROUND, REMOTE CAPACITY, BATTERY					


# Grand total: 40

Location: Supply From: Mounting: Surface Enclosure: Type 1  Notes:			Volts: 120/240 Single  Phases: 1  Wires: 3  Mains Type:  Mains Rating: 100 A  MCB Rating: 100 A									
СКТ	Circuit Description	Trip	Poles		<b>A</b>	E		Poles	Trip	Circuit Des	cription	CK
1	LIGHTS	20 A	1		1200 VA			1	20 A	REFIGERATOR, GFCI BRE	•	2
3	RECEPTACLES	20 A	1			360 VA	500 VA	1	20 A	LIGHTS		4
5	Receptacle	20 A	1	1260 VA	180 VA			1	20 A	EXTERIOR SIGN RECEPTA	ACLE	6
7	Receptacle	20 A	1			900 VA	1200 VA	1	20 A	MICROWAVE		8
9	WATER LIEATER	40.4	40.4		3000 VA 360 VA			1 :	20 A	INTERIOR SIGN LIGHT RECEPTACLES		10
11	WATER HEATER	40 A	2			3000 VA	180 VA	1	20 A	BREAKROOM RECEPTACI	LE	12
13	Receptacle	20 A	1	180 VA	360 VA			1	20 A	CONFERENCE ROOM RECEPTACLES		14
15	COPIER	20 A	1			360 VA	360 VA	1	20 A	BREAKEROOM RECEPTAG	CLES	16
17	Spare	20 A	1	0 VA	720 VA			1	20 A	RECEPTACLES		18
		To	tal Load:	760	5 VA	6860	VA					<u>'</u>
		Tot	tal Amps:	63	8 A	57	Α					
Legend Load Cl	assification	Connec	ted Load	De	emand Fa	ctor	Estimate	ed Deman	d	Panel	Totals	
Lighting		845	5 VA		125.00%	<b>)</b>	105	56 VA				
Other		600	0 VA		100.00%		600	00 VA		Total Conn. Load: 14465 VA		
Power			VA		0.00%		0	VA		Total Est. Demand:		
Receptacle		762	0 VA		100.00%		762	20 VA		Total Conn.: 60 A		
										Total Est. Demand:	61 A	

NOTE: EC SHALL COMPLY WITH NEC110.22a "EACH DISCONNECTING MEANS SHALL BE LEGIBLY MARKED TO INDICATE ITS PURPOSE UNLESS LOCATED AND ARRANGED SO THE PURPOSE IS EVIDENT. THE MARKING SHALL BE OF SUFFICIENT DURABILITY TO WITHSTAND THE ENVIRONMENT INVOLVED." AND 408.4A, "CIRCUIT DIRECTORY OR CIRCUIT IDENTIFICATION. EVERY CIRCUIT AND CIRCUIT MODIFICATIONS SHALL BE LEGIBLY IDENTIFIED AS TO ITS CLEAR, EVIDENT AND SPECIFIC PURPOSE OR USE. ETC." EC SHALL MEET ALL REQUIREMENTS OF THESE ENTIRE SECTIONS. SCHEDULES SHOWN ON THESE PLANS ARE SHORT HAND DESIGNATIONS FOR THE DESIGN AND ARE ONLY TO BE USED FOR CONSTRUCTION. FINAL SCHEDULES SHALL MEET THE REQUIREMENTS OF THE TWO CODE SECTIONS INDICATED IN THIS NOTE.

3 DIRECTIVE FOR PANEL SCHEDULES No Scale



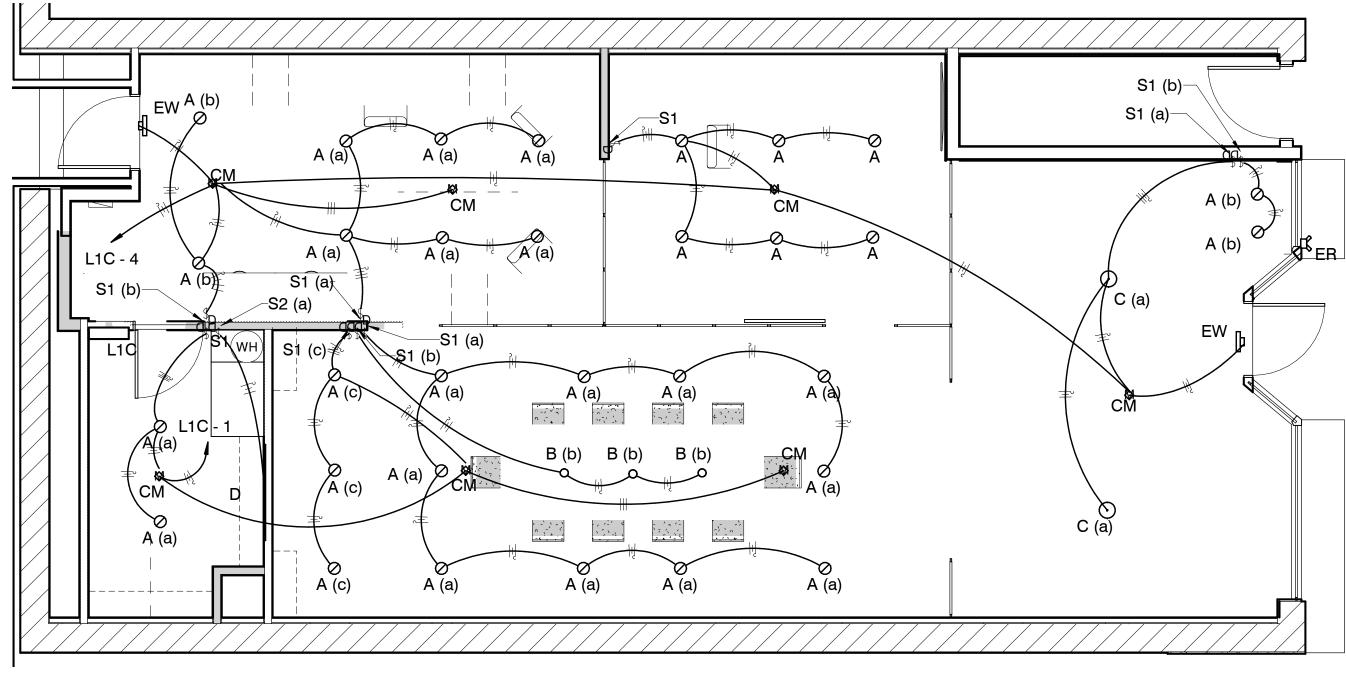

2 FIRST FLOOR - LIGHTING PLAN
1/4" = 1'-0"

COMMUNICATIONS DEVICE SCHEDULE							
Type Mark	Count	Description					
T\/	2	BOX FOR TV AT TV HEIGHT 3/4" CONDUIT WITH PULL STRING FROM BOX TO ABOVE ACCESSABLE DROP CELLING					

TV 2 BOX FOR TV AT TV HEIGHT, 3/4" CONDUIT WITH PULL STRING FROM BOX TO ABOVE ACCESSABLE DROP CEILING Grand total: 2

DATA DEVICE SCHEDULE							
Type Mark Count Description							
D2	6	BOX FOR DATA AND PHONE, 3/4" CONDUIT FROM BOX UP TO ABOVE ACCESSABLE DROP CEILING WITH PULL STRING					
Grand total: 6		·					



GUST ENGINEERING 2621 RIGDEN PARKWAY, SUITE C5 FORT COLLINS, COLORADO 80525 970-482-1776 mgust@gustengineering.com

GUST ENGINEERING 3612 PIONEER AVENUE CHEYENNE, WYOMING 82001 307-638-2511 mgust@gustengineering.com

No.	Description	Date

FRAMEWORKS OFFCE # 3
OLD TOWN SQUARE
POWER AND LIGHTING
REMODEL PLANS AND
SCHEDULES

Project number

Date

Drawn by

Checked by

Project Number

3-12-2021

MHG

MHG

E-1
Scale As indicated

3/22/2021 11:17:16 AM



#### LIGHTING WATTAGE WORKSHEET

**Space-by-Space Method** 

To comply with Fort Collins adopted commercial energy code 2018 IECC, a lighting wattage worksheet must be submitted for new buildings and whenever 50% or more of the lighting changed, added or replaced for a tenant finish. Find the applicable allowances recorded in section C405. Record these allowances with floor area to the allowance table. Sum up the Total Interior Lighting Power Allowance for this table. Keeping this allowance in mind, list every new light fixture and its individual wattage on the Proposed Interior Connected Lighting Power worksheet. Sum the proposed lighting and verify that this is equal or less than the Allowance. When the proposed is greater than the Allowance, lighting fixtures must be removed or replaced with lower wattage fixtures. Along with a lighting plan, submit the completed Lighting Wattage worksheets for review and approval. The lighting wattage form from the ComCheck program can also be used.

WATTAGE ALLOWANCE: SPECIFIC SPACE METHOD (2018 IECC table C405.3.2(2)

WATTAGE	RELOWANCE. SPECIFIC SPACE METHOD (2018 FE	WATTAGE ALLOWANCE. SPECIFIC SPACE METHOD (2016 TECC Table C405.5.2(2)										
Room Number	Specific Space Activity	Area square feet	Allowed watts/sq.ft.	Total allowed watts								
	Total Interior	Lighting Pow	er Allowance:									

#### PROPOSED INTERIOR CONNECTED LIGHTING POWER

I KOI OCED	Number of Wetter on Draw and										
		Number of	Watts per	Proposed							
Location	Fixture description (lamp/bulb type and quantity)	fixtures	fixture	watts							
	Total Interior L	ighting Watta.	ge Proposed:								

#### **TABLE C405.3.2(2)**

### INTERIOR LIGHTING POWER ALLOWANCES:


#### **SPACE-BY-SPACE METHOD**


	LPD		
COMMON SPACE TYPES <sup>a</sup>	(watts/sq.ft)		
Atrium			
Less than (<) 40 feet in height	0.03 per		
Less than (<) 40 feet in height	ft/height		
Greater than (>) 40 feet in height	0.40+0.02		
Greater than (>) 40 reet in height	per ft/height		
Audience seating area			
In an auditorium	0.63		
In a convention center	0.82		
In a gymnasium	0.65		
In a motion picture theater	1.14		
In a penetentiary	0.28		
In a performing arts theater	2.03		
In a religious building	1.53		
In a sports arena	0.43		
Otherwise	0.43		
Banking activity area	0.86		
Breakroom (See Lounge/breakroom)			
Classroom/lecture hall/training room			
In a penetentiary	1.34		
Otherwise	0.96		
Computer room	1.33		
Conference/meeting/multipurpose	1.07		
Copy /print room	0.56		
Corridor	_		
In a facility for the visually impaired	0.92		
(not used primarily by staff) <sup>b</sup>	0.32		
In a hospital	0.92		
In a manufacturing facility	0.29		
Otherwise	0.66		
Courtroom	1.39		
Dining area			
In a bar/lounge or leisure dining	0.93		
In a cafeteria or fast food dining	0.63		
In a facility for the visually impaired	2.00		
(not used primarily by staff)b	2.00		
In family dining	0.71		
In a penetentiary	0.96		
Otherwise	0.63		
Electrical/mechanical room	0.43		
Emergency vehicle garage	0.41		
Food preparation area	1.06		
Guestroom <sup>c,d</sup>	0.77		
Laboratory			
In or as a classroom	1.20		

CE METHOD	LPD
COMMON SPACE TYPES <sup>a</sup>	(watts/sq.ft)
Otherwise	1.45
Laundry/washing area	0.43
Loading dock, interior	0.58
Lobby	
For an elevator	0.68
In a facility for the visually impaired	2.03
(not used primarily by staff) <sup>b</sup>	1.05
In a hotel	1.06
In a motion picture theater	0.45
In a performing arts theater	1.7
Otherwise	1.0
Locker room	0.48
Lounge/breakroom	
In a healthcare facility	0.78
Otherwise	0.62
Office	
Enclosed	0.93
Open plan	0.81
Parking area, interior	0.14
Pharmacy area	1.34
Restroom	
In a facility for the visually impaired	0.96
(not used primarily by staff) <sup>b</sup>	
Otherwise	0.85
Sales area	1.22
Seating area, general	0.42
Stairway (see space containing stairway)	
Stairwell	0.58
Storage room	0.46
Vehicular maintenance area	0.56
Workshop	1.14
DI III DINIC TYPE CRECIEIS CRACE TYPECa	LPD
BUILDING TYPE SPECIFIC SPACE TYPES <sup>a</sup>	(watts/sq.ft)
Automotive (see vehicular maintenace a	rea)
Convention center-exhibit space	0.88
Dormitory-living quarters <sup>c,d</sup>	0.54
Facility for the visually impaired <sup>b</sup>	
In a chapel (not used by primary staff)	1.06
In rec room (not used by primary staff)	1.80
Fire station-sleeping quarters <sup>c</sup>	0.20
Gymnasium/fitness center	-
In an exercise area	0.50
In a playing area	0.82
(continued)	

(continued)

a	LPD			
BUILDING TYPE SPECIFIC SPACE TYPES <sup>a</sup>	(watts/sq.ft)			
Healthcare facility	•			
In an exam/treatment room	1.68			
In an imaging room	1.06			
In a medical supply room	0.54			
In a nursery	1.00			
In a nurse's station	0.81			
In an operating room	2.17			
In an patient room <sup>c</sup>	0.62			
In a physical therapy room	0.84			
In a recovery room	1.03			
Library	•			
In a reading area	0.82			
In the stacks	1.20			
Manufacturing facility	•			
In a detailed manufacturing area	0.93			
In an equipment room	0.65			
In an extra-high-bay area > 50' high	1.05			
In a low-bay-area 25'-50' high	0.75			
In a low-bay-area < 25' high	0.96			
Museum				
In a general exhibition area	1.05			
In a restoration room	0.85			
Performing arts theater dressing rm	0.36			
Post office-sorting area	0.68			
Religious buildings				
In a fellowship hall	0.55			
In a worship/pulpit/choir area	1.53			
Retail facilities				
In a dressing/fitting room	0.5			
In a mall concourse	0.9			
Sports arena-playing area				
For a Class I facility <sup>e</sup>	2.47			
For a Class II facility <sup>f</sup>	1.96			
For a Class III facility <sup>g</sup>	1.7			
For a Class IV facility <sup>h</sup>	1.13			
Transportation facility	•			
In a baggage/carousel area	0.45			
In an airport concourse	0.31			
At a terminal ticket counter	0.62			
Warehouse-storage area	•			
For med to bulky, palletized items	0.35			
For smaller, hand-carried items	0.69			

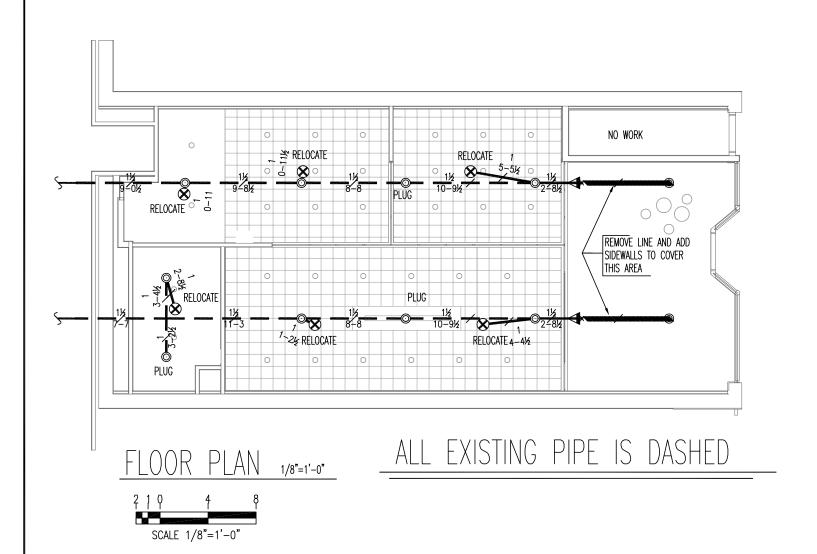

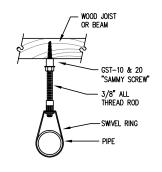

HANGER DETAIL

NOT TO SCALE

I HERE-BY CERTIFY THAT THIS DOCUMENT WAS PREPARED BY ME OR UNDER MY DIRECT SUPERVISION. I AM A DULY LICENSED NICET III

BRUCE & THOMAS

IGNATURE

BRUCE S THOMAS-ENGINEERING TECHNICIAN NICET LICENSE# 98592 FIRE PROTECTION

DATE: 2-18-2021

MN STATE LICENSE# CO-78

# OWNER RESPONSIBILITY

SPECIAL NOTE——ALL AREAS THAT
ARE CONDITIONED MUST NOT DROP
BELOW 40 DEGREES. ANY DROP BELOW
40 DEGREES MAY CAUSE THE SYSTEM
TO FREEZE.

SCOPE OF WORK

RELOCATE HEADS FOR NEW TENANT

## GENERAL NOTES

- 1. SYSTEM PER NFPA 13 2016
- 2. HANGERS PER NFPA 13 2016
- 3. SYSTEM WILL NOT BE TESTED
- 4. 1" PIPE TO BE SCH 30 WLS
- 5. SCREWED PIPE TO HAVE DUCTILE IRON SCREWED FITTINGS
- 6. ALL HEADS IN LIGHT HAZARD AREAS TO BE QUICK RESPONSE

HD'S	S THIS SHEET 8	SPRINKL	SPRINKLER'S			TAL	HD'S JC	Drawing Title FIRE PROTECTION		
SYM.	DESCRIPTION	SIN	Туре	DEG.	K	NPT	Finish	ESC	Qty	Title
	EXISTING 1" OUT-LET									Contract No. 21-024
<b>⊗</b>	RELIABLE MOD G5 CONCEALED	RA3415	PENDENT	155	5.6	1/2"	WHITE	CONCEALED	6	DESIGN LINE CO-78
<b>1</b> ×	RELIABLE MOD F1FR56	RA1435	HORZ SIDEWALL	155	5.6	1/2"	CHROME	FLAT	2	Drawn By: BRUCE THOMAS 763-274-0768
										Scale: AS NOTED
										Date: 2/18/21
										Approval By: CITY

## FLOW FIRE PROTECTION, INC 3054 LAKE CANAL COURT / UNIT 100 FORT COLLINS, CO 80524

COLORADO STATE LIC # 21-S-04285

COLORADO STATE BACKFLOW LIC #21-B-08191

Job:

FRAMEWORKS OFFICE
3 OLD TOWN SQUARE
FORT COLLINS, CO

SHEET 1 OF 1