

Historic Preservation Services

Community Development & Neighborhood Services 281 N. College Ave.
Fort Collins, CO 80524

970.224.6078 preservation@fcgov.com fcgov.com/historicpreservation

REPORT OF ALTERATIONS TO DESIGNATED RESOURCE

Site Number/Address: 628 Peterson St. Laurel School National Register Historic District ISSUED: 6/10/2024

Douglas J. and Kristi D. Buffington 628 Peterson St. Fort Collins, CO 80524

Dear Property Owners:

This report is to document proposed alterations to the Hardinger Residence, at 628 Peterson St., pursuant to Fort Collins Municipal Code Chapter 14, <u>Article IV</u>. A copy of this report may be forwarded to the Colorado Office of Archaeology and Historic Preservation.

The alterations include: Screened porch rear addition

Our staff review of the proposed work finds the alterations meet the <u>SOI Standards for Treatment</u> of Historic Properties. A summary is provided below:

Applicable Code Standard	Summary of Code Requirement and Analysis (Rehabilitation)	Standard Met (Y/N)		
SOI #1	A property will be used as it was historically or be given a new use that requires minimal change to its distinctive materials, features, spaces, and spatial relationships; This addition will not change the residential use of the property.			
SOI #2	The historic character of a property will be retained and preserved. The removal of distinctive materials or alteration of features, spaces, and spatial relationships that characterize a property will be avoided.	Y		
	Because this addition is on the rear of the property, behind another modern addition, the historic character of the property is retained, and distinctive materials or spatial relationships on the property are not negatively impacted.			

SOI #3	Each property will be recognized as a physical record of its time, place, and use. Changes that create a false sense of historical development, such as adding conjectural features or elements from other historic properties, will not be undertaken.	Y
	Attached to another modern addition from the early 2000s, the proposed addition does not create a false sense of historical development.	
SOI #4	Changes to a property that have acquired historic significance in their own right will be retained and preserved.	N/A
SOI #5	Distinctive materials, features, finishes, and construction techniques or examples of craftsmanship that characterize a property will be preserved.	Y
	Because this screened porch addition is entirely attached to a non-historic part of the house, distinctive materials, features, finishes, construction techniques and examples of craftsmanship characteristic of the historic home are preserved.	
SOI #6	Deteriorated historic features will be repaired rather than replaced. Where the severity of deterioration requires replacement of a distinctive feature, the new feature will match the old in design, color, texture, and, where possible, materials. Replacement of missing features will be substantiated by documentary and physical evidence.	N/A
SOI #7	Chemical or physical treatments, if appropriate, will be undertaken using the gentlest means possible. Treatments that cause damage to historic materials will not be used.	N/A
SOI #8	Archeological resources will be protected and preserved in place. If such resources must be disturbed, mitigation measures will be undertaken.	Y
	Although there is not reason to believe that there is a likelihood of uncovering archaeological resources during any excavation needed for this project, the applicant should be advised of this standard and, should any such resources be found, please contact Historic Preservation Services immediately for assistance at 970-224-6078 or preservation@fcgov.com .	

SOI #9	New additions, exterior alterations, or related new construction shall not destroy historic materials that characterize the property. The new work shall be differentiated from the old and shall be compatible with the massing, size, scale, and architectural features to protect the historic integrity of the property and its environment. Again, due to the placement of this addition, no historic materials will be destroyed to accommodate its construction. The attachment of the addition to the home through an existing window opening and the attempt to salvage floor beam material also minimizes the loss of materials in general. The work is differentiated from the old primarily in its roof form and in the simplicity of some design choices, such as the gable-end shingles, which reference those on the front of the house but are less complicated in pattern. The design of the addition is also compatible with the historic home in several ways, such as through using the same siding and through the proportion/type of the screened openings, which refer to those openings on the	Y
SOI #10	house's façade. New additions and adjacent or related new construction will be undertaken in such a manner that, if removed in the future, the essential form and integrity of the historic property and its environment would be unimpaired.	Y
	Due to the placement of the addition on the rear of the house, attached to another addition, if it were desired to remove it in the future, the essential form and integrity of the historic house and its environment would be unimpaired.	

If you have any questions regarding this review, please contact me. I can be reached at yjones@fcgov.com or at 970-224-6078.

Sincerely,

Yani Jones Historic Preservation Planner



COMMUNITY DEVELOPMENT & NEIGHBORHOOD SERVICES

281 N. College Ave. • Fort Collins, CO 80524 • Phone: 970.416.2740 • www.fcgov.com/building

BUILDING PERMIT APPLICATION

APPLICATION NUMBER:	FOR OFFICE USE	FOR OFFICE USE APPLICATION DATE:		
Job Site Address		Unit#		
PROPERTY OWNER INFO: (All owner	r information is required – NOT op	tional)		
Last Name	First Name	Middle		
Street Address	City	State	Zip	
Phone #	Email			
Name of Business (COMMERCIAL USE O	NLY)			
CONTRACTOR INFO: Company Nam				
License Holder Name		LIC #	CERT #	
LEGAL INFO:				
Subdivision/PUD	Filing #Lot #	Block #Lot S	q Ft	
CONSTRUCTON INFO: Total Building	g Sq Ft (NOT including basement)	Total Garage Sq. Ft		
Residential Sq FtCommer	cial Sq Ft# of Stories	_Bldg Ht# of Dwellir	ng Units	
1st Floor Sq Ft2nd Floor S	Sq Ft3rd Floor Sq Ft	Unfinished Basement S	q Ft	
Finished Basement Sq Ft	# of Bedrooms	# of Full Baths		
¾ Baths½ Baths	# Fireplaces			
ENERGY INFORMATION: (CHECK ONE)				
Prescriptive Performance] U/Arescheck□ ERI □ ASH	RAE Component/Comch	eck 🗌 IDAP 🗌	
Air Conditioning? YES	NO 🗆			
City of Fort Collins Approved Stock P	lan # SPO List Option	n #s		
<u>Utilities INFO:</u> New Electric Service □ Elec	tric Sonvice Ungrado 🗆 — Electric	Motor Polocation		
Electric Main Breaker Size (Residenti				
	Electric Temp Pedes	·		
ZONING INFO: (COMMERCIAL USE C	•			
Proposed Use: (i.e. medical, office, bar	nk, retail, etc.)			
For Commercial remodels and tenar		wing questions:		
Is the remodel/tenant finishes for an	existing or new tenant? (Please ch	eck one)		
Existing Tenant□ Ne	ew Tenant□			
If for a new tenant, is this the first te	nant to occupy this space?			
Yes No If not for t	the initial tenant for this unit, what w	as the previous use of this te	nant space?	
Are there any exterior building chang	ges (including mechanical) associate	ed with the work? Yes [□ No □	
If yes, please describe:				

Value of Construction (ma	aterials and labor): \$		
Description of Work:			
JOBSITE SUPERVISOR CO	NTACT INFO: Name	Phone	
SUBCONTRACTOR INFO:	Electrical	Mechanical	
		Roofing	
		Other	
		tate of Colorado Senate Bill 13-152, property owners, apply wing been inspected for Asbestos Containing Materials (ACM	
☐ I do not know if a	n asbestos inspection has been co	nducted on this property.	
☐ An asbestos inspe	ection has been conducted on this	property on or about (enter date)	
☐ An asbestos inspe	ection has not been conducted on	this property.	
comply with all requiremen	ts contained herein and City of Fort C	on and state that the above information is correct and ollins ordinances and state laws regulating building cons	_
Applicant Signature	Mm.	Type or Print Name	
Phone #	Fmail		

THIS APPLICATION EXPIRES 180 DAYS FROM APPLICATION DATE



Building permit fees are based on Occupancy Category and Square Footage. Occupancy Categories are typically located on the architectural plans for submittal. A summary of each occupancy category is also included in the following pages as well.


Required for permit submittal - Fill out the following table:

Occupancy Category	Square Footage	Multiply square	Cost	Total
(See Description of Occupancies Below)		foot by cost per	per Square	
		square foot.	Foot	
A (Assembly)		x	\$0.40	
B (Business)		х	\$0.50	
E (Education/Schools)		х	\$0.50	
F (Factory)		х	\$0.35	
(Institutional)		х	\$0.50	
M (Mercantile)		х	\$0.40	
R-1 (Hotel)		х	\$0.35	
R-2 (Apartment)		х	\$0.35	
R-3 (Single Family Detached/Duplex)		х	\$0.65	
R-4 (Assisted Living)		х	\$0.55	
S (Storage)		х	\$0.40	
U (Utility)		х	\$0.40	
H High hazard		х	\$0.60	
Core and Shell Buildings		х	\$0.45	
No designated occupancy type at construction)				
			Total	

^{****}Occupancies and fees will be verified at plan review to ensure occupancy categories and square footages are accurate. Fees will be re-assessed if occupancies and square footages do not match plans.****

For additions that include interior remodel: please provide addition square footage above and remodel only			
valuation here			
Please note: overall valuation provide on building permit application will be used for taxes only. Remodel only valuation will be used			
to calculate plan check fee and building permit fee for addition.			
For Now Multi family buildings fill out the following:			

۷e	w Multi-	family buildings fill out the following:			
1.	Are there any areas/functions, other than dwelling units in this building (examples: leasing office, gym,				
	commu	nity gather areas, storage, garage, facilities office)?			
		Yes - there are other functions/occupancy areas. Required: list each in the table above			
		No - only dwelling units			
2.	Are the	se other areas/functions/ occupancy types available to the public (examples: public gym or pool, event			
	spaces,	store/shops/salons, etc.)?			
		Yes (Mixed Use Building) - there are other occupancies/amenities available to the public.			
		No (Multi-Family Building) - the other occupancies/amenities are only available to the residents of the			
		building.			

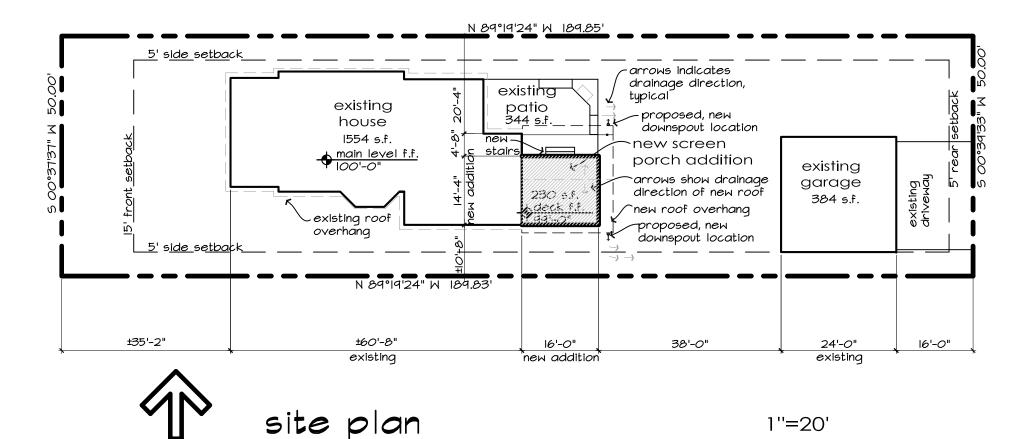

SITE NOTES

Builder shall provide positive drainage away from structure and across site.

Property lines, the location of the existing structures and property lines are based on an iplot plan completed by Landmark Engineering datedJuly 30, 2019.

Builder shall provide proper compaction of all backfill areas.

Builder shall coordinate utility services and relocation of meters if deemed necessary.


LEGAL DESCRIPTION

1''=20'


S 1/2 LOT 10, BLK 156, FTC

ADDRESS

628 PETERSON STREET FORT COLLINS, COLORADO

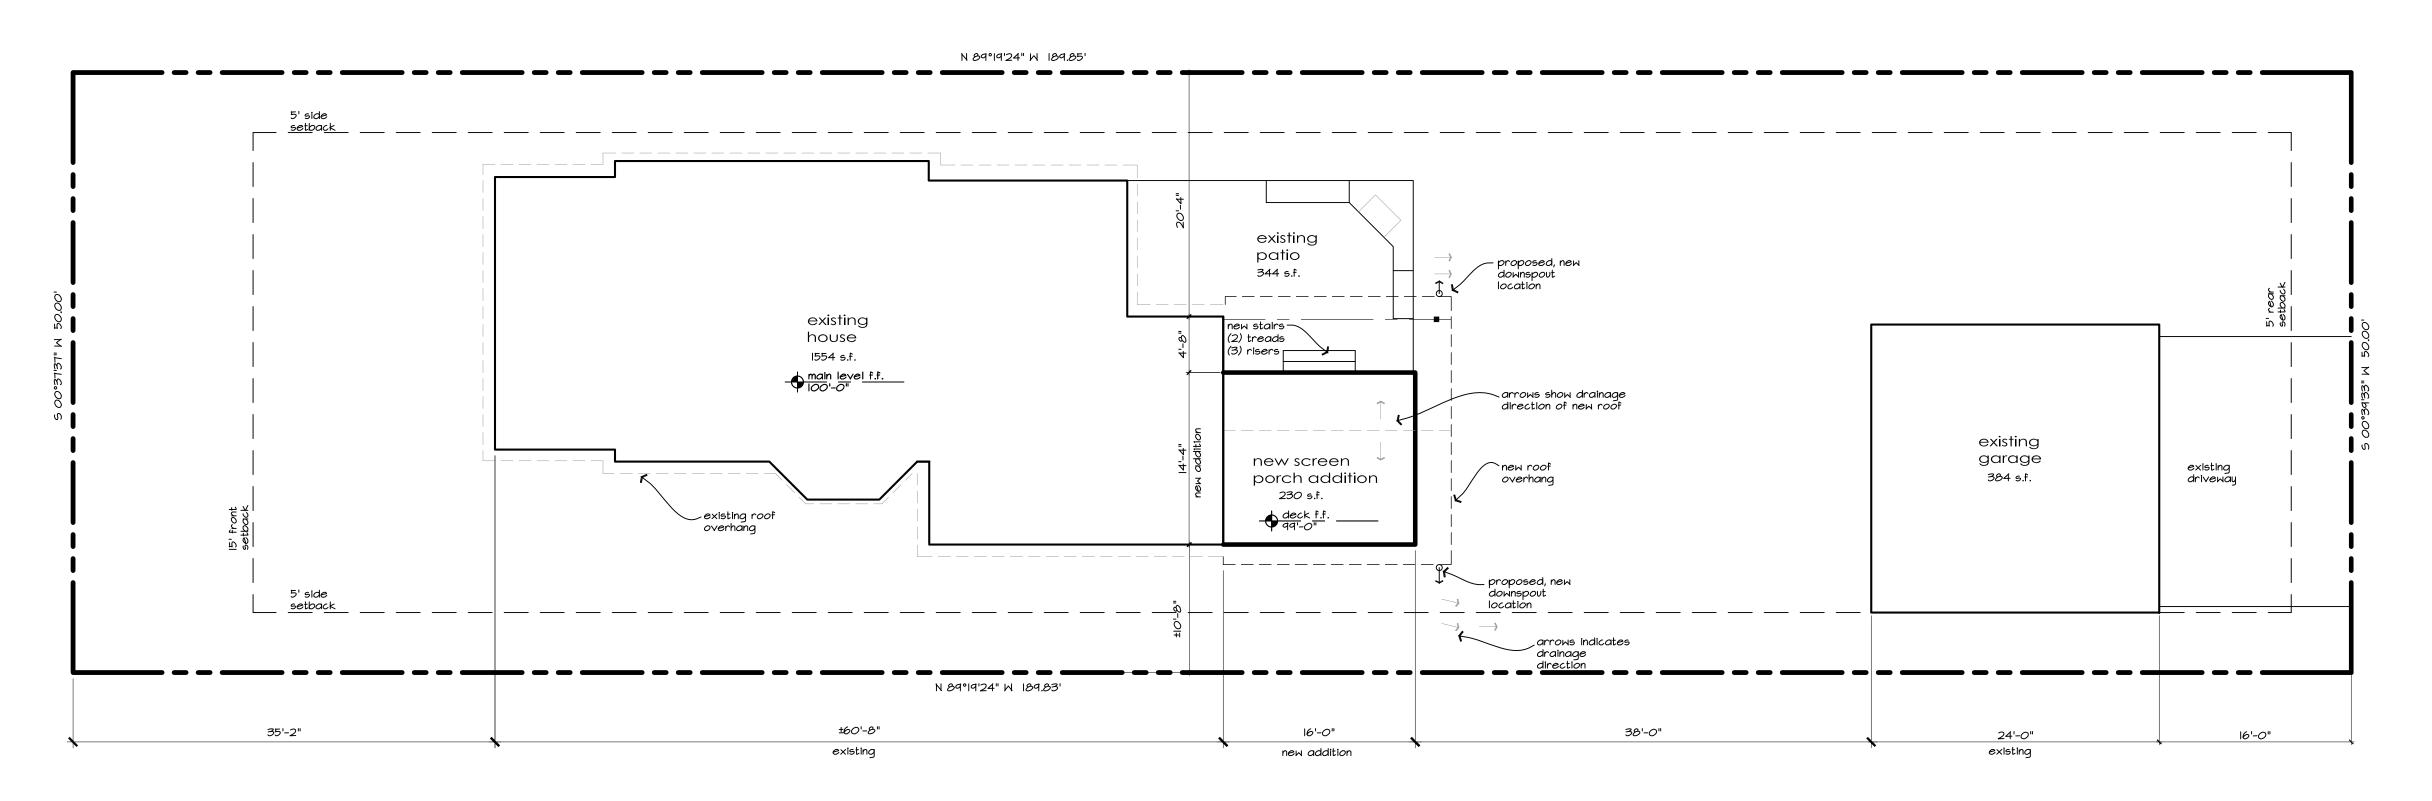



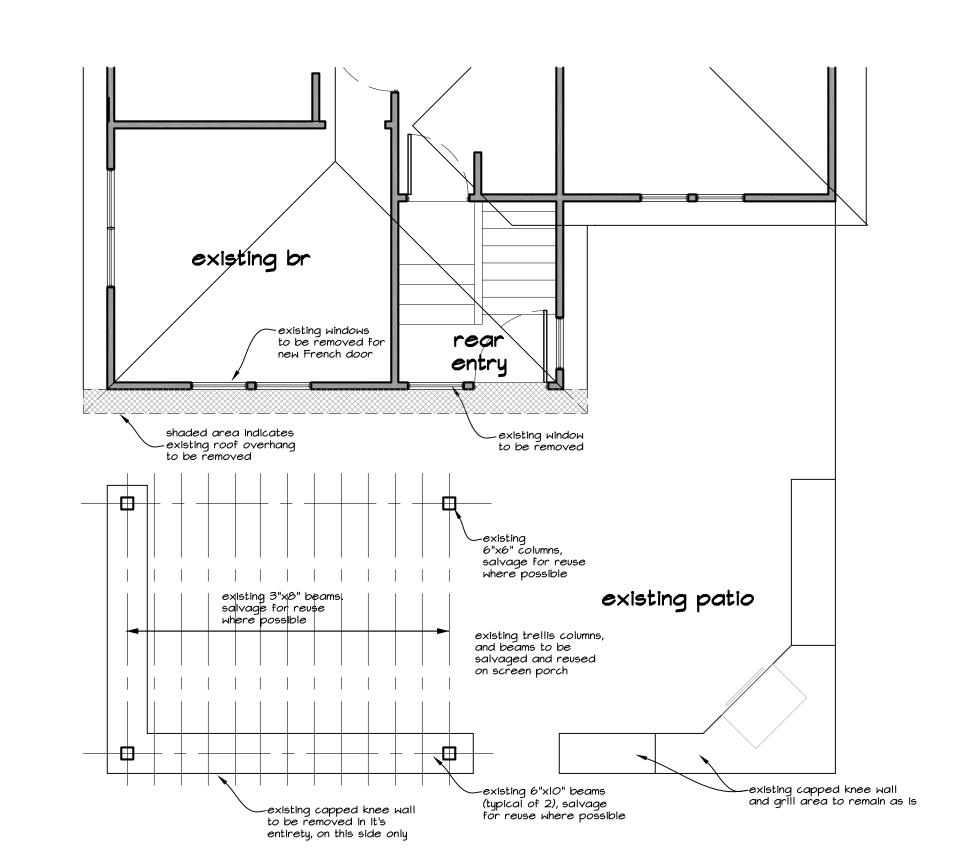

demo plan 1/4

GENERAL NOTES

These drawings are "builders plans" indicating general design intent only. It is the builder's responsibility to provide any additional construction details required and to dictate methods of construction. The builder shall verify all dimensions of manufactured components and relationships between materials or components. The builder shall verify existing conditions and dimensions shown on the drawings including all existing grades at the site.

The architectural designer shall be notified in writing of any discrepancies or deficiencies in the drawings prior to construction. Failure to notify the architectural designer shall constitute acceptance by the builder of all responsibility.

Any changes to these plans without prior written consent by the architectural designer shall constitute acceptance by the builder and owner of that change.

The contractor shall provide mechanical and electrical engineering as required to complete work and for intended purpose. Mechanical contractor shall verify dimensions of all necessary flue chases, ducts & equipment.

The builder/contractor and all subcontractors shall conform to all applicable building codes.

SITE NOTES

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LEGAL DESCRIPTION

S 1/2 LOT 10, BLK 156, FTC

ADDRESS

628 PETERSON STREET FORT COLLINS, COLORADO

DRAWING INDEX

AI SITE PLAN, GENERAL NOTES DEMO PLAN A2 DEMO PLAN, FLOOR PLAN, OVERALL ROOF PLAN, LIGHTING PLAN

A3 EXTERIOR ELEVATIONS, BUILDING SECTIONS & WALL SECTION

STRUCTURAL DRAWINGS BY
TD STRUCTURAL ENGINEERING
SI FOUNDATION PLAN/ MAIN LEVEL
FLOOR FRAMING PLAN, ROOF FRAMING
PLAN & DETAILS & NOTES

SITE PLAN & DEMO PLAN

> Architectural Design by Kim Morton Phone: (970) 482-8267


628 Peterson Fort Collins, Co Oug and Kristi Bu


Permit Set

date: January II 2024


drawn by: KM

△| of 3

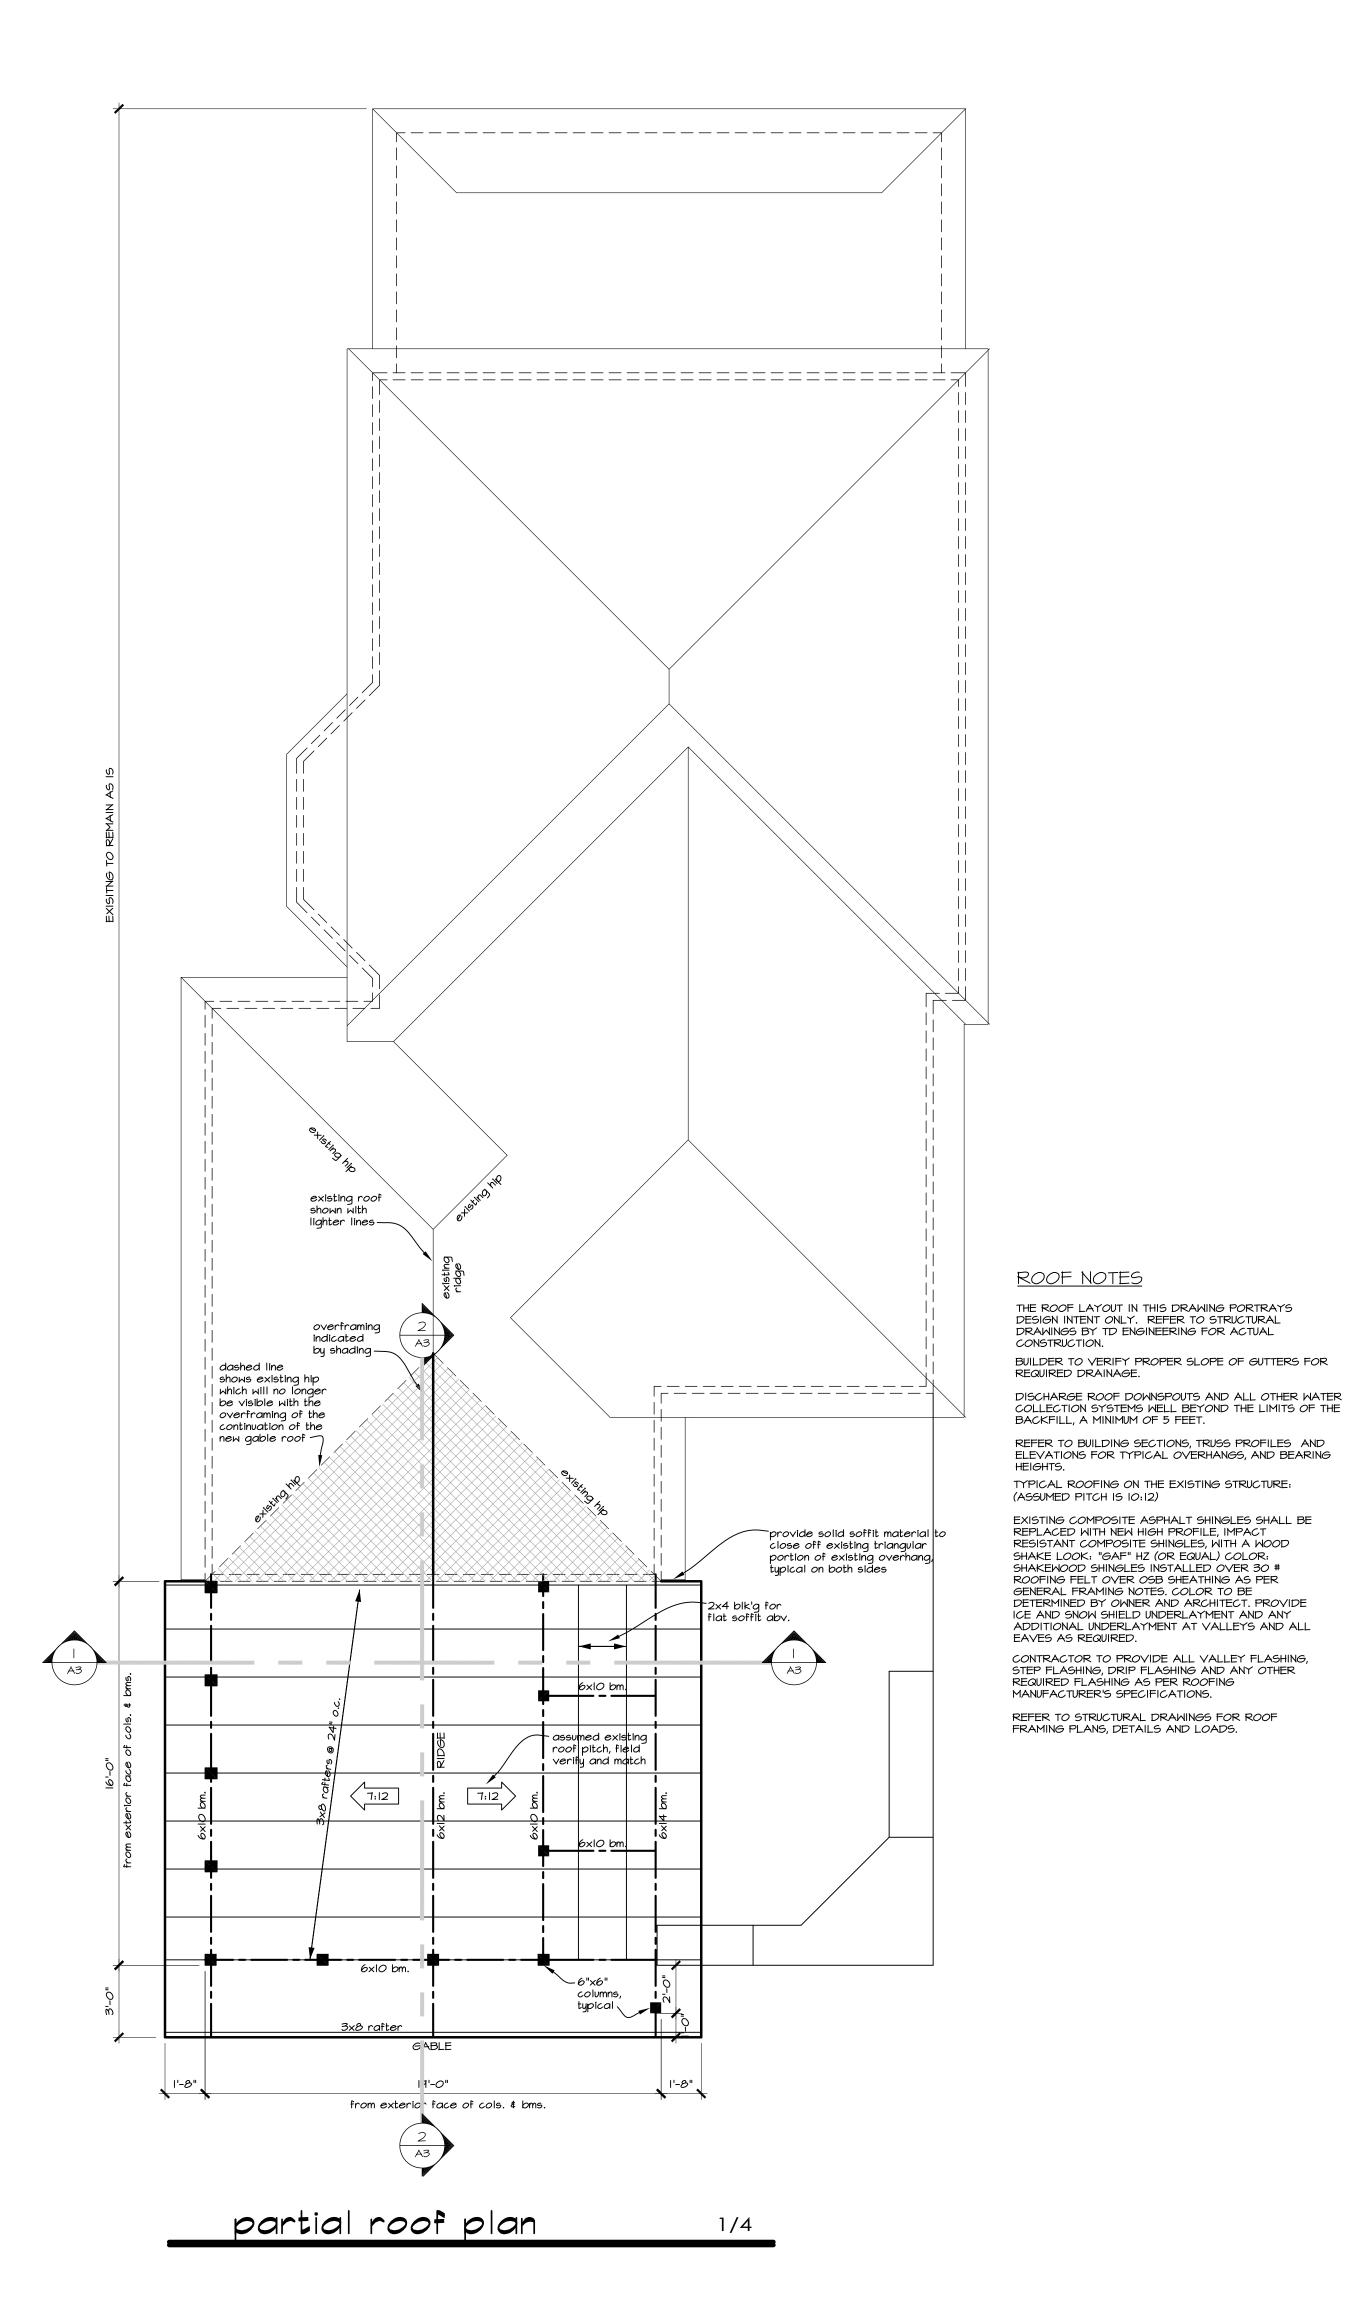

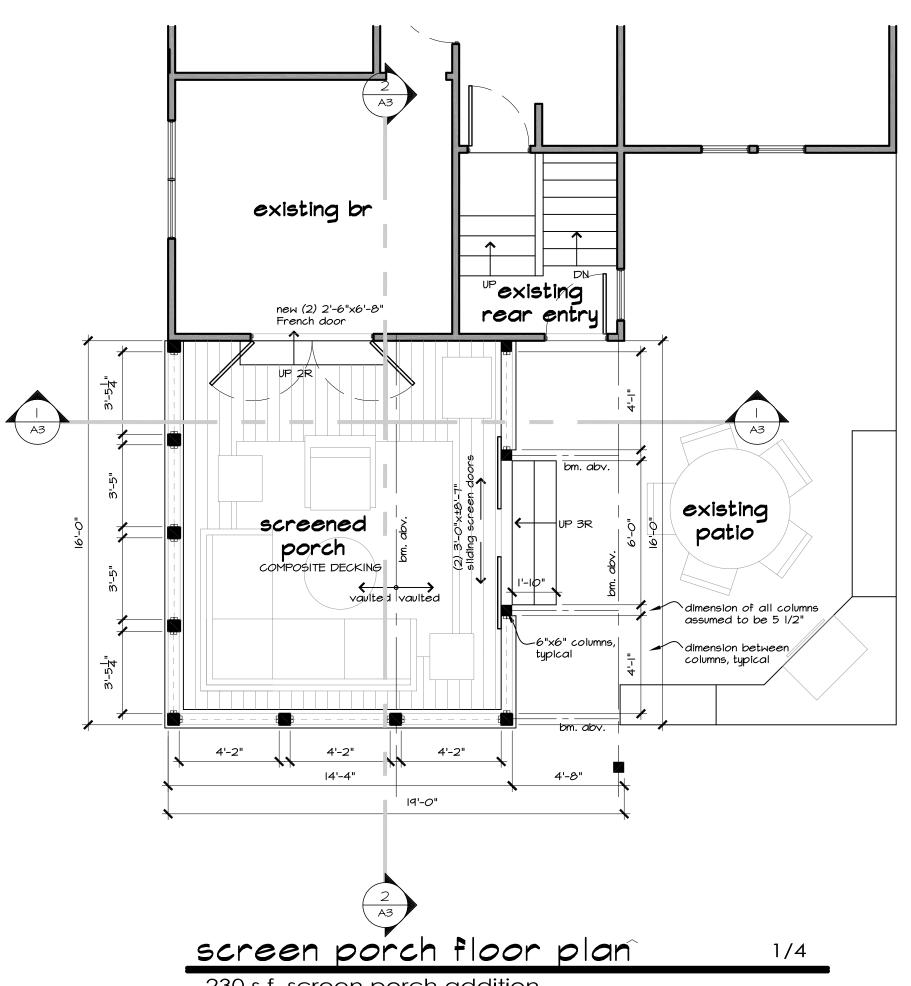

230 s.f. screen porch addition

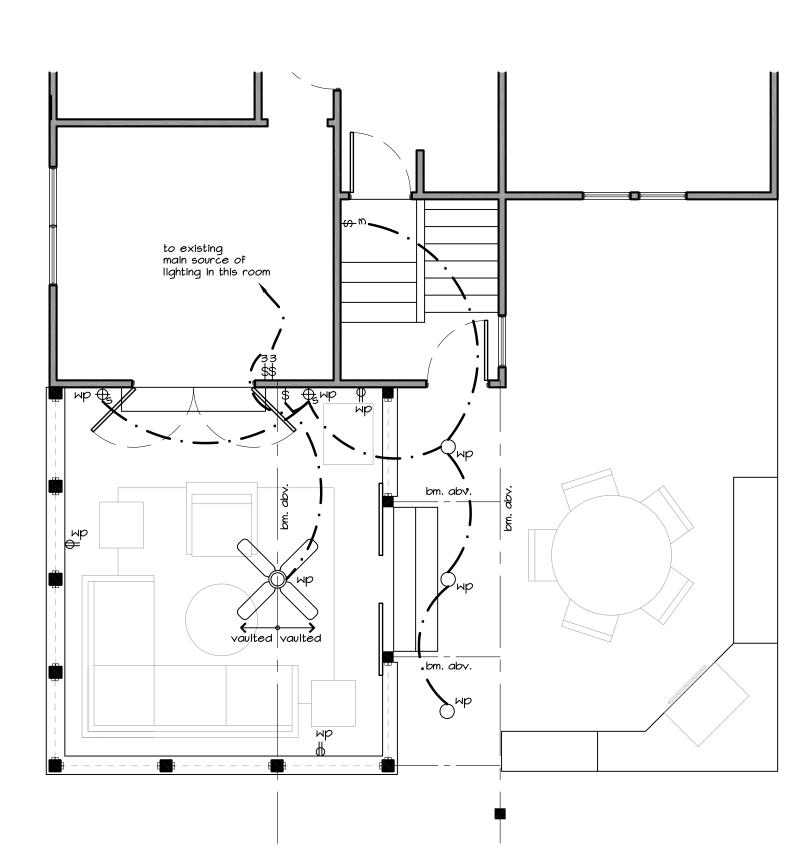

<u>SWITCHES</u> \$ SINGLE POLE SWITCH

ELECTRICAL AND LIGHTING NOTES:

This electrical plan is a representation of the architectural designer's lighting and fixture design. All bids and electrical installations are to be governed by current code

responsibility of the electrical contractor to bid and install electrical requirements for this project in compliance with all adopted local codes. Notify designer and builder of any code discrepancies in these drawings prior to submitting

110 VOLT DUPLEX WEATHERPROOF RECEPTACLE

IIO VOLT DUPLEX RECEPTACLE IN CLG.

WALL MOUNTED LIGHT FIXTURE / SCONCE

INDICATES WATER PROOF FIXTURE/ RATED

requirements as well as the designer's intent. It is the

Verify all fixture types and locations with owners.

Provide gfi outlets where required by code.

ELECTRICAL LEGEND

RECEPTACLES

LIGHT FIXTURES

\$3 THREE WAY SWITCH

RECESSED CAN LIGHT

FOR EXTERIOR USE


DEMO PLAN, FLOOR PLAN, OVERALL ROOF PLAN & ELECTRIC PLAN

drawn by: KM


Permit Set

date: January II 2024

revisions

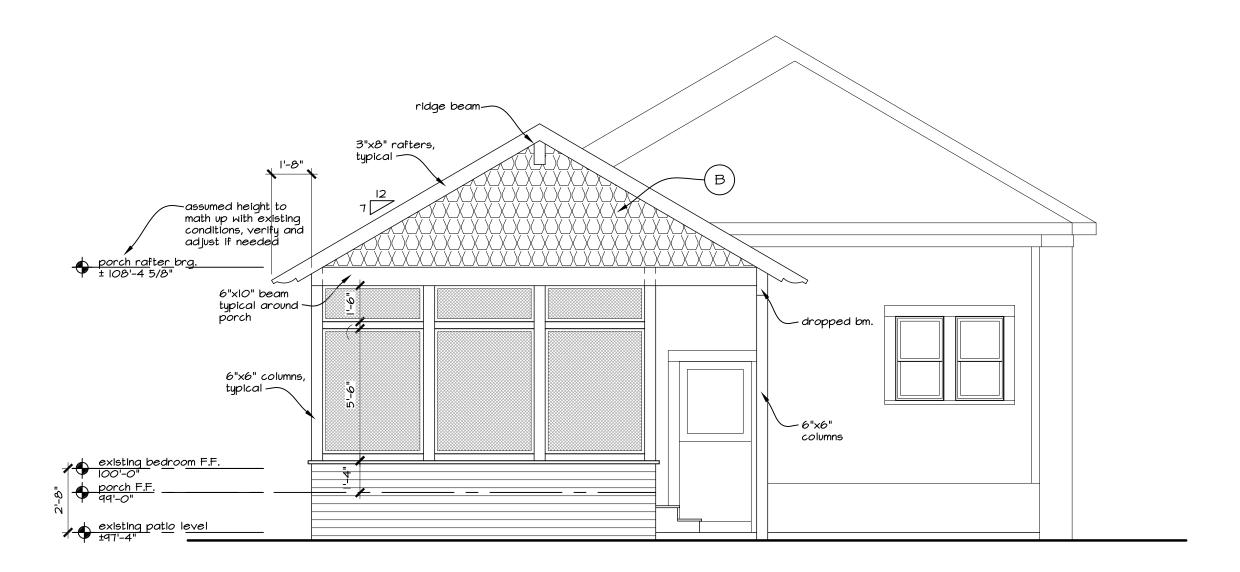

rear elevation 1/4 (east)

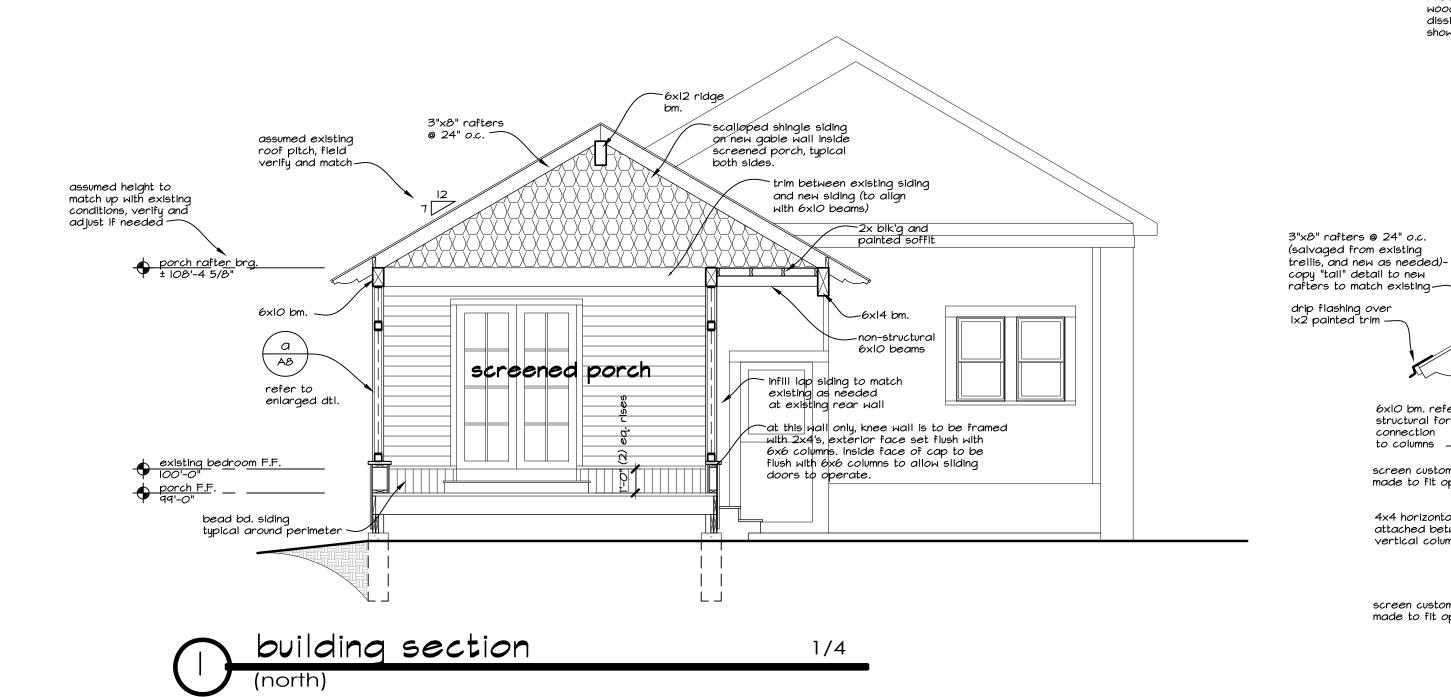

EXTERIOR MATERIAL NOTES:

LAP SIDING Match the material and size of new lap siding and trim to be the same as existing siding and trim over (1) layer 'Tamlyn Homewrap" (or equal) drainable building wrap over sheathing as specified by structūral engineer

LAP SIDING INSTALLATION NOTES:

- prepare material as per manufacturer's specifications prior to - color to be coordinated w/ owner

CEDAR SCALLOPED SHINGLES Cedar scalloped shingles over (1) layer 'Tamlyn Homewrap" (or equal) drainable building wrap over o.s.b. shtng as specified by

structural engineer (typ. where shown) Verify exact pattern and size of shingle with owners. INSTALLATION NOTES: - prepare material as per manufacturer's specifications prior to

- color to be coordinated w/ owner ROOFING MATERIAL NOTE:

"GAF" Timberline HDZ 50 year (or equal) ul 21218 class 4 impact resistant "class A" high profile asphalt shingles over (1) layer 30# building felt and ice and water shield at valleys and all eaves as required or (1) continuos layer of ice and water shield over osb sheathing as per general framing notes. Style and color to match existing. Weave in new shingles to existing to make transition as seamless as possible.

INSTALLATION NOTES:

-Provide ice and snow shield underlayment and any additional underlayment at valleys and all eaves as required. - Flash all valleys as per manufacturer's recommendations.

FLASHING

6x10 bm. refer to

made to fit opening—

4x4 horizontal member attached between vertical columns -

connection

to columns —

screen custom

screen custom

6x6 continuos

4x4 horizontal member attached between

2x8 knee wall capped with 5/4'x12" top

lap siding over building wrap and sheathing

(A) wall section

to match existing siding on house —

dropped beam

from pier to

vertical columns —

6x6 column lines up with exterior face of knee wall

made to fit opening—

Provide all roof flashing, wall-to-deck flashing, flashing above wood headers in siding, window headers flashing, flashing between dissimilar materials, parapet cap flashing and any other flashing shown or not shown for water tight construction.

— sheathing to be painted and exposed on interior Use Ix6

sheathing and apply bed board

- composite decking over 2x10 p.t. joists per structural

- 6x6 column and

concrete pier (beyond) refer to structural

for dtls and connection


– provide bug screen between decking and joists

soffit to underside, in-between

tag, or exterior rated

— blk and hurricane tie


per structural engineer

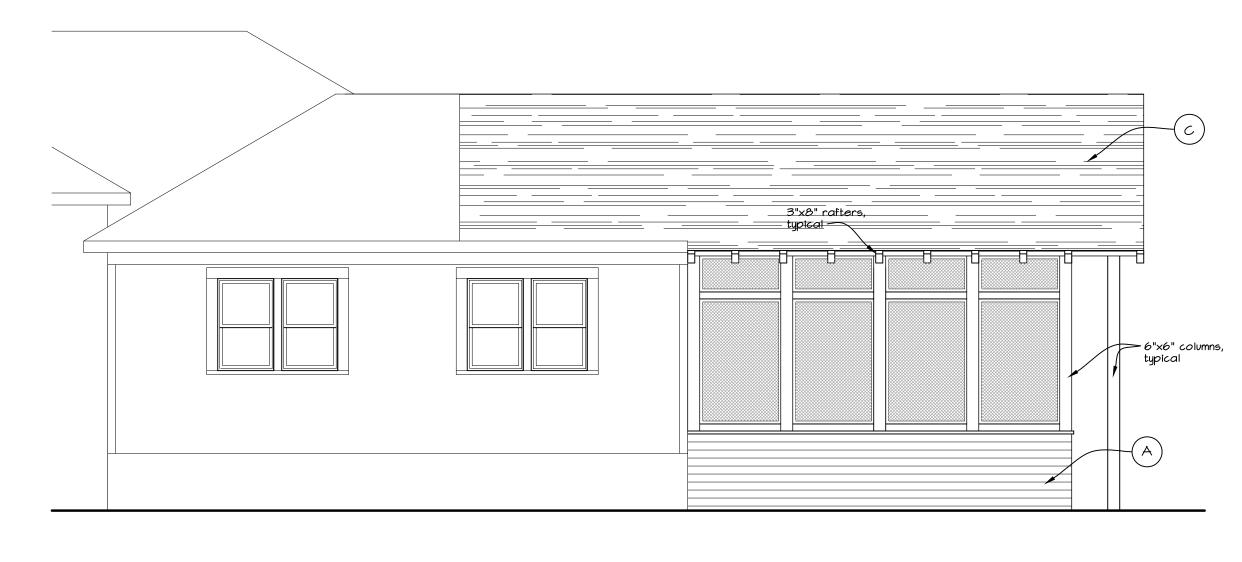



side elevation (south)

side elevation

(north)

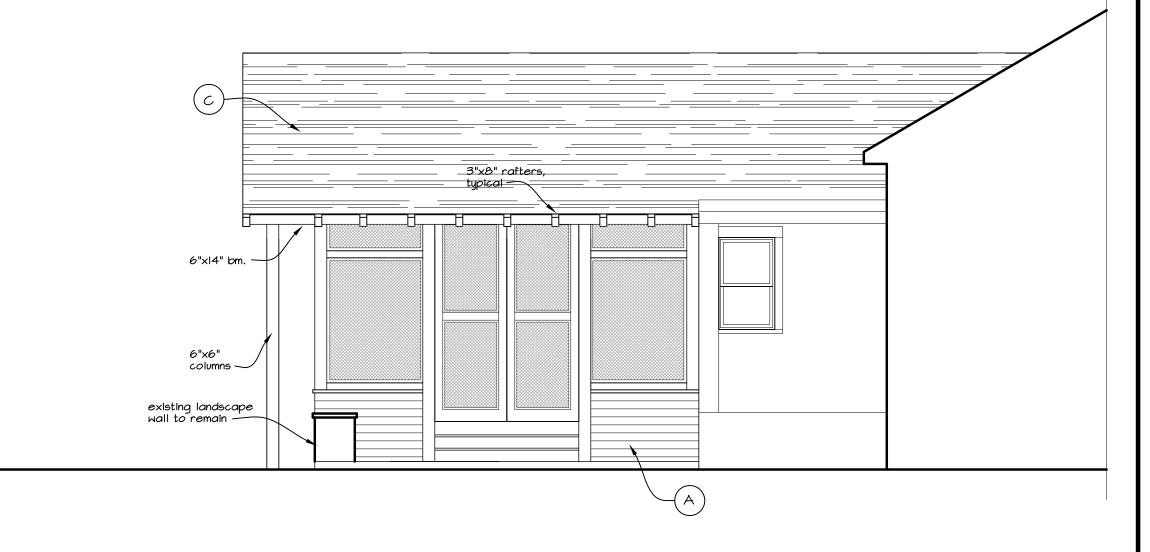

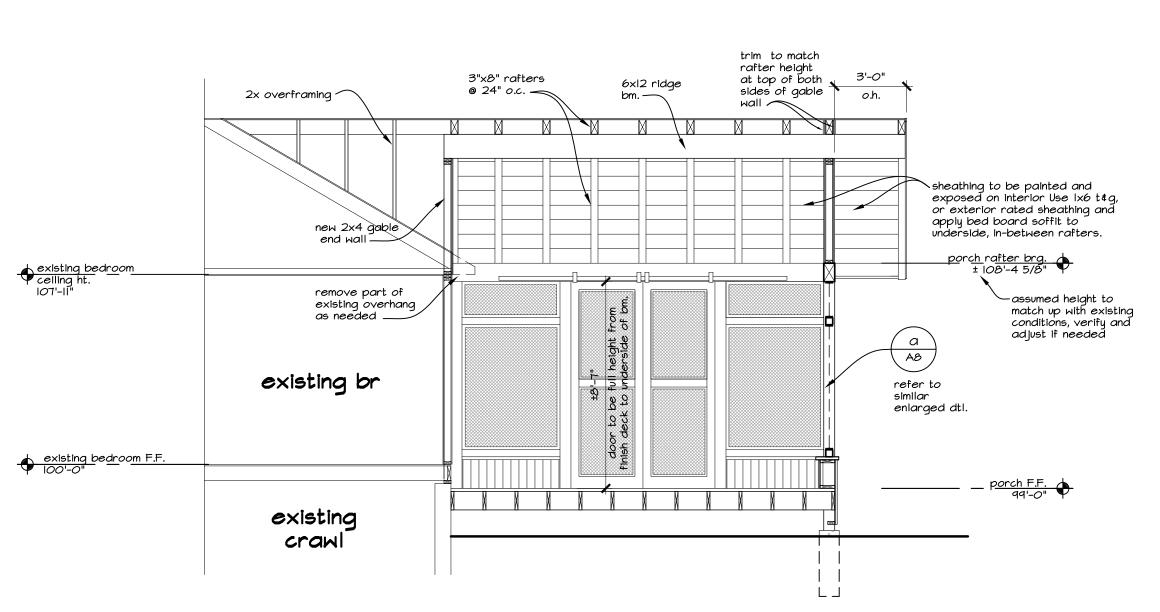

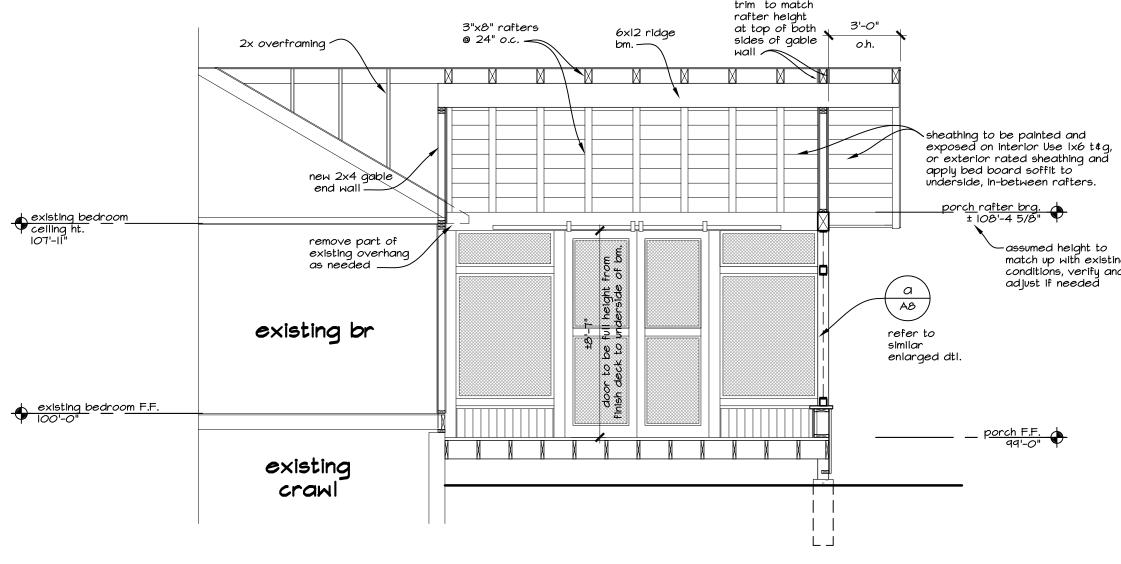



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Kristi ete o<u>≡</u> 628 Fort

EXTERIOR ELEVATIONS, BUILDING SECTIONS & WALL SECTION

drawn by: KM date: January II 2024

Permit Set

REVISIONS

A3 of 3

Structural General Notes

1. Design Load

Design Codes: 2021 IRC, ASCE 7-16, ACI332, 2018 NDS and classified as a Category [II] structure

Roof Loads:

Roof Dead Load	20 psf
Ground Snow Load, Pg	35 psf
Flat Snow Load, Pf	30 psf
onow Exposure Factor, Ce	1.0
Snow Thermal Factor, Ct	1.1
onow Importance Factor, Is	1.0

Floor Loads

Floor Dead Load 12 psf Floor Live Load 40 psf

Wind Loads

Design Wind Speed, Vult (3 sec gust)

Wind Exposure

Internal Pressure Coefficient

140 mph

B

0.18 (enclosed)

Seismic Loads:

Seismic Design Category B
Soil Site Class D
Analysis Procedure ELF

2. Foundation Design:

a. foundation design is based on assumed bearing values maximum bearing capacity = 1500 psf

maximum bearing capacity = 1500 minimum dead load = n/a

b. foundation specifications
l. all piers to bear on native undisturbed soil
2. the foundation excavation shall be observed by the geotechnical engineer of record.

3. General Requirements:

a. construction method:

the structural drawings represent the final structure. the drawings do not indicate the contractors means, methods, techniques, sequences of construction and job safety. the engineer of record is not responsible for the contractor's failure to follow plans, specifications, and/or engineering recommendations, nor is the engineer of record responsible for economic loss and/or delays on the contractor or subcontractors.

all construction shall be adequately braced to prevent distortion and damage due to construction loads and natural forces. the contractor shall make allowances for difference between temperature during erection and mean temperature when structure is completed and in service.

b. trade coordination:

the structural drawings are to be used in conjunction with the architectural, electrical, mechanical, plumbing and site drawings. conflicts in dimension and interference shall be directed to the architect prior to construction.

c. specifications:

if conflicts arise from the recommendations of these drawings and those contained in the specifications, the architect and engineer shall be notified of the discrepancy prior to construction.

d. drawing dimensions:

no dimension is to be determined by scaling the drawings or details. If a dimension is not indicated on the drawings and is needed, contact the structural engineer for clarification. If discrepancies are found between the structural drawings and the architectural drawings, contact the structural engineer or architect for clarification.

4. Materials:

a. foundation concrete: f'c = 3000 psi foundation, f'c - 4000psi garage slab on grade; minimum of 5-1/4 sacks of type i-ii portland cement per cubic yard; air entrained with $6\% \pm 1\%$ air.

b. reinforcing steel: fy = 60 ksi (60 grade). all reinforcing shall be placed in accordance with aci recommendations including minimum laps, spacings and corner bars.


- c. wood framing lumber shall be stress graded Hem-Fir, Doug Fir, or Southern Yellow Pine (treated) no. 2 unless noted a. timber connectors called for on the drawings are as manufactured by Simpson company. connectors by other manufacturers may be used if the load capacity is equal to or greater than the connector specified. use manufacturer's furnished nails and bolts.
- b. fasten all wood members with common nails according to the building code unless otherwise noted.


 c. roof sheathing shall be 15/32" sheathing rated for exterior use with an APA span rating of 32/16. nail roof sheathing with 8d nails at 4" on center at panel edges and 12" on center in the field u.n.o.

FOOTING / PAD SCHEDULE				
MARK	DIAMETER	DEPTH	REINFORCING	
PR12	1'-0"	36"	2-#4 FULL HT	
PR18	1'-6"	36"	4-#4 FULL HT	

NOTIFY TD STRUCTURAL ENGINEERING IF
EXISTING CONDITIONS VARY FROM THAT
SHOWN HERE OR ON ARCHITECTURAL PLANS


NOTIFY TD STRUCTURAL ENGINEERING AND ARCHITECT IMMEDIATELY IF DISCREPANCIES BETWEEN PLANS

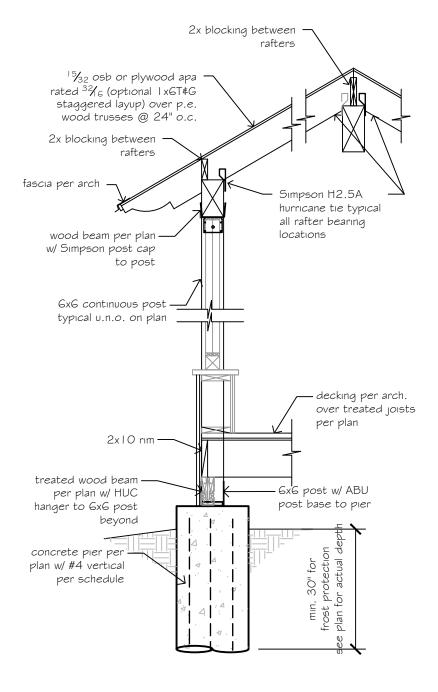

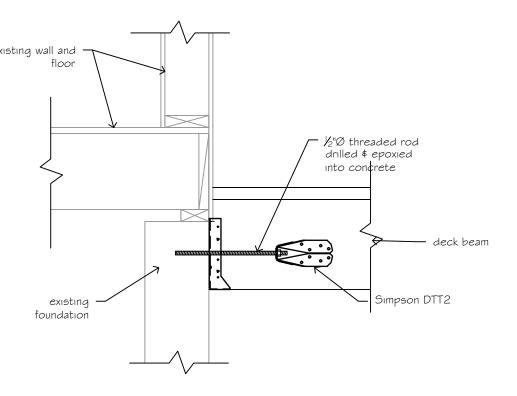






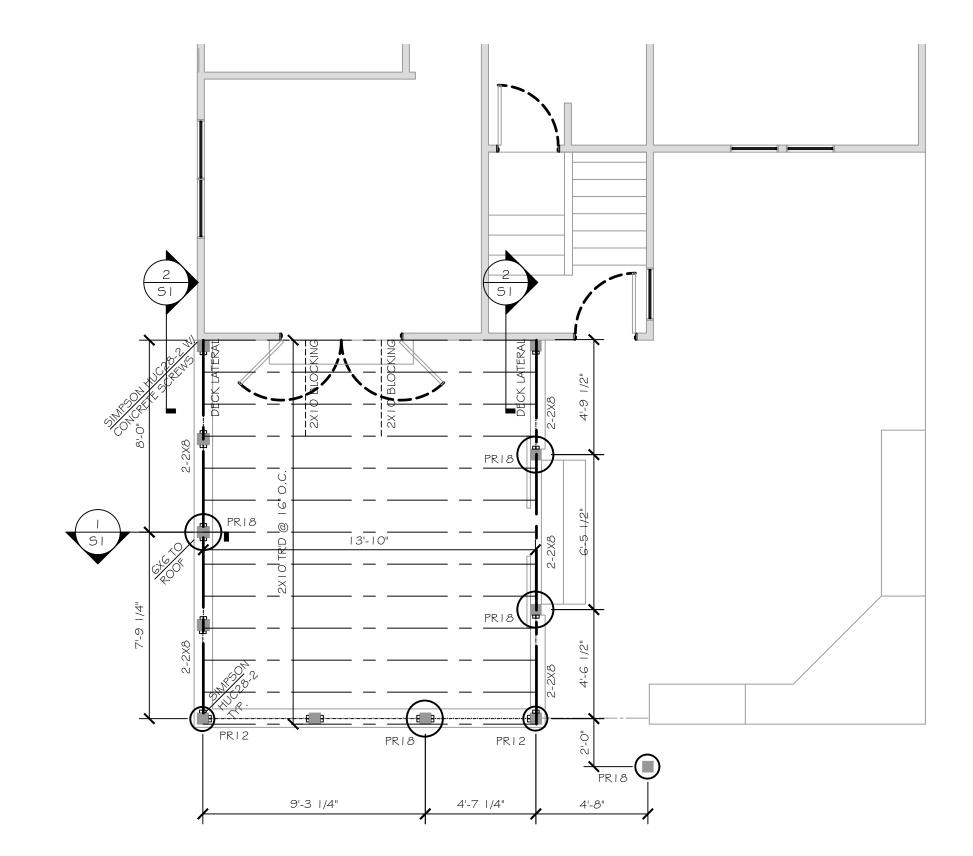

TOUNDATION AND FLOOR FRAMING PLAN

PLAN N

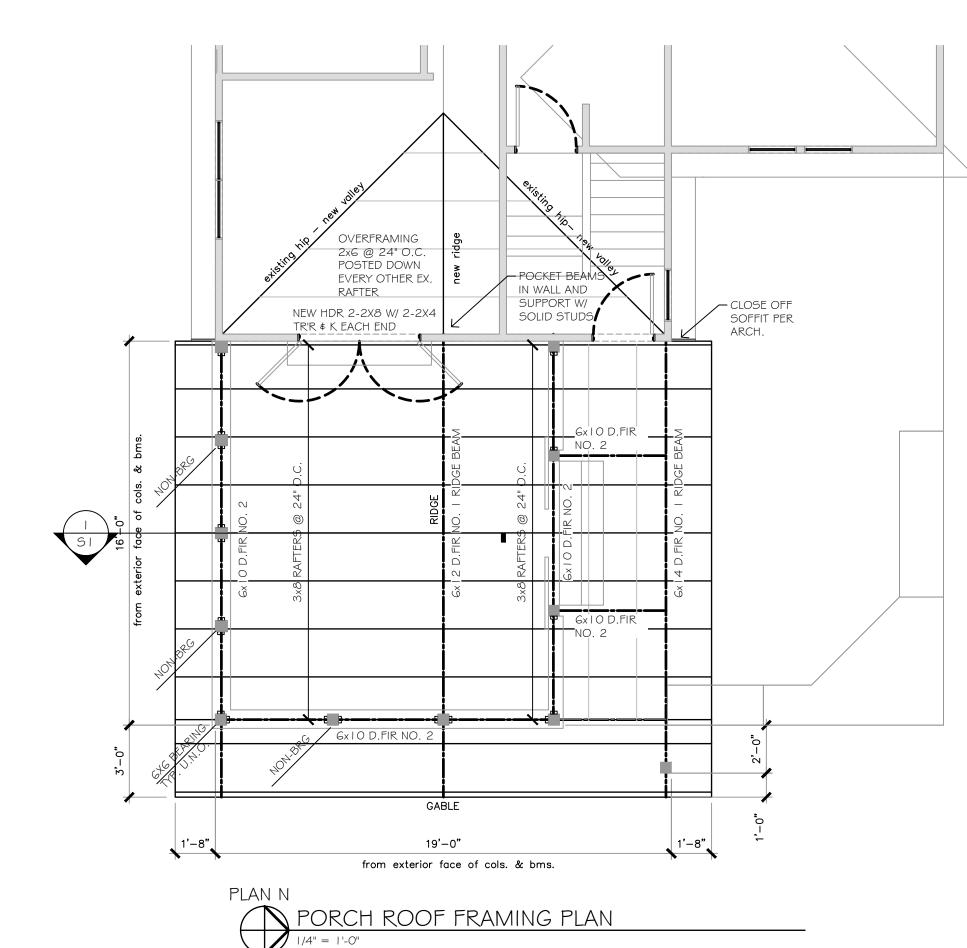


Drawings, specifications, general notes and outline specifications are instruments of service and shall remain the property of TD Structural Engineering, Inc. Copies of these documents retained by the client are for the clients use in the construction of the project for which these documents were prepared. Any use of these documents, in whole or in part, by any means whatsoever to construct any other project or the use of these documents, in whole or in part, as stock plans or prototype design for multiple building projects is strictly prohibited, except with the specific written consent of TD Structural Engineering, Inc. of Northern Colorado.

TD STRUCTURAL ENGINEERING INC

2909 Oxford Court Fort Collins, Colorado 80525
970.372.1140

www.tdstructural.com

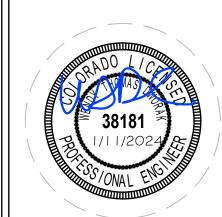

UFFINGTON SCREENED PORC 628 PETERSON STREET FORT COLLINS COLORADO

PROJECT NUMBER: 23-103
DESIGNED BY: WTD
REVIEWED BY: WTD

DATE FOR ISSUE:1/11/2024

REVISION:

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FOUNDATION & FRAMING PLANS DETAILS & NOTES

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