

Historic Preservation Services

Community Development & Neighborhood Services 281 N. College Ave. Fort Collins, CO 80524

970.224.6078

preservation@fcgov.com
fcgov.com/historicpreservation

CERTIFICATE OF APPROPRIATENESS ISSUED: August 15, 2024 EXPIRATION: August 15, 2025

Colleen Webb c/o David Kaplan, Elevated Design Build, LLC 144 Racquette Dr. Fort Collins, CO 80524

Dear Property Owner:

This letter provides you with confirmation that the proposed changes to your designated Fort Collins landmark property, the G.R. McDaniel House I at 632 Peterson St., been approved by the City's Historic Preservation Division because the proposed work meets the criteria and standards in Chapter 14, <u>Article IV</u> of the Fort Collins Municipal Code.

1) Replace 2 non-historic windows (basement, bathroom) with awning-type Fibrex units

Notice of the approved application has been provided to building and zoning staff to facilitate the processing of any permits that are needed for the work.

Please note that all ensuing work must conform to the approved plans. Any non-conforming alterations are subject to stop-work orders, denial of Certificate of Occupancy, and restoration requirements and penalties.

If the approved work is not completed prior to the expiration date noted above, you may apply for an extension by contacting staff at least 30 days prior to expiration. Extensions may be granted for up to 12 additional months, based on a satisfactory staff review of the extension request.

Property owners can appeal staff design review decisions by filing a written notice of appeal to the Director of Community Development & Neighborhood Services within fourteen (14) days of this decision. If you have any questions regarding this approval, or if I may be of any assistance, please do not hesitate to contact me. I can be reached at yjones@fcgov.com or at 970-224-6078.

Sincerely,

Yani Jones Historic Preservation Planner

Applicable Code Standard	Summary of Code Requirement and Analysis (Rehabilitation)	Standard Met (Y/N)
SOI #1	A property will be used as it was historically or be given a new use that requires minimal change to its distinctive materials, features, spaces, and spatial relationships;	Y
	This project will not alter the residential use of this property.	
SOI #2	The historic character of a property will be retained and preserved. The removal of distinctive materials or alteration of features, spaces, and spatial relationships that characterize a property will be avoided.	Y
	This house is an example of a Dutch Colonial Revival residence, built c. 1907, that was likely originally owned by G.R. McDaniel, a Fort Collins contractor and carpenter.	
	Because these are non-historic window units being replaced, there will not be an impact on the historic character of the property, and so this Standard is met.	
SOI #3	Each property will be recognized as a physical record of its time, place, and use. Changes that create a false sense of historical development, such as adding conjectural features or elements from other historic properties, will not be undertaken.	N/A
SOI #4	Changes to a property that have acquired historic significance in their own right will be retained and preserved.	N/A
SOI #5	Distinctive materials, features, finishes, and construction techniques or examples of craftsmanship that characterize a property will be preserved.	Y
	Again, because the windows proposed for replacement are not historic, their removal still conforms to this Standard.	

SOI #6	Deteriorated historic features will be repaired rather than replaced. Where the severity of deterioration requires replacement of a distinctive feature, the new feature will match the old in design, color, texture, and, where possible, materials. Replacement of missing features will be substantiated by documentary and physical evidence. The basement window proposed for replacement is clearly not historic. It is a plexiglass unit that is dissimilar from the nearby wood basement window in its design. The other window proposed for replacement is an upper floor shower window; although there are no known historic photos showing this elevation of the home, it is likely that this is a non-historic window because its form is dissimilar from other windows on this house, and the window casing is also lacking the decorative	Y
	trim present on all of the other windows. The replacement unit proposed for the basement window is similar in design to the existing historic basement window, with a grille simulating the 3 vertical lites. The bathroom window replacement is a simple awning window similar to what is there now. This Standard is considered met for these reasons.	
SOI #7	Chemical or physical treatments, if appropriate, will be undertaken using the gentlest means possible. Treatments that cause damage to historic materials will not be used.	N/A
SOI #8	Archeological resources will be protected and preserved in place. If such resources must be disturbed, mitigation measures will be undertaken.	N/A
SOI #9	New additions, exterior alterations, or related new construction shall not destroy historic materials that characterize the property. The new work shall be differentiated from the old and shall be compatible with the massing, size, scale, and architectural features to protect the historic integrity of the property and its environment.	N/A
SOI #10	New additions and adjacent or related new construction will be undertaken in such a manner that, if removed in the future, the essential form and integrity of the historic property and its environment would be unimpaired.	N/A



COMMUNITY DEVELOPMENT & NEIGHBORHOOD SERVICES

281 N. College Ave. • Fort Collins, CO 80524 • Phone: 970.416.2740 • www.fcgov.com/building

BUILDING PERMIT APPLICATION

APPLICATION NUMBER:	FOR OFFICE USE	APPLICATION DATE:	
Job Site Address Unit#			
PROPERTY OWNER INFO: (All owner	information is required – NOT op	tional)	
Last Name	First Name	Middle	
Street Address	City	State	Zip
Phone #	Email		
Name of Business (COMMERCIAL USE ON	LY)		
CONTRACTOR INFO: Company Name			
License Holder Name		LIC #(CERT #
LEGAL INFO:			
Subdivision/PUD	Filing #Lot #	Block #Lot So	q Ft
CONSTRUCTON INFO: Total Building	Sq Ft (NOT including basement)	Total Garage Sq. Ft.	
Residential Sq FtCommerc	ial Sq Ft# of Stories	_Bldg Ht# of Dwellin	g Units
1st Floor Sq Ft2nd Floor So	q Ft3rd Floor Sq Ft	Unfinished Basement So	q Ft
Finished Basement Sq Ft	# of Bedrooms	# of Full Baths	
¾ Baths½ Baths	# Fireplaces		
ENERGY INFORMATION: (CHECK ONE)			
Prescriptive Performance	U/Arescheck□ ERI □ ASF	RAE ☐ Component/Comche	eck 🗌 IDAP 🗌
Air Conditioning? YES \(\square\)	10 🗆		
City of Fort Collins Approved Stock Pla	an # SPO List Option	n #s	
<u>Utilities INFO:</u> New Electric Service ☐ Elect	ric Sarvica Ungrado 🗆 — Electric	Motor Polocation	
Electric Main Breaker Size (Residentia			
	·	stal? Yes \(\sigma\) No \(\sigma\)	
ZONING INFO: (COMMERCIAL USE O	·	7.COT. 1.CO	
Proposed Use: (i.e. medical, office, bank			
For Commercial remodels and tenant		wing questions:	
Is the remodel/tenant finishes for an	existing or new tenant? (Please ch	neck one)	
Existing Tenant□ Nev	w Tenant□		
If for a new tenant, is this the first ten	ant to occupy this space?		
Yes No If not for the	ne initial tenant for this unit, what w	vas the previous use of this ter	nant space?
Are there any exterior building change	es (including mechanical) associate	ed with the work? Yes	□ No □
If yes, please describe:			

Value of Construction (materi	als and labor): \$			
Description of Work:				
JOBSITE SUPERVISOR CONTAC	CT INFO: Name	Phone		
SUBCONTRACTOR INFO: Ele	ctrical	Mechanical		
Plumbing	Framing	Roofing		
		Other		
		State of Colorado Senate Bill 13-152, property owners, applying flaving been inspected for Asbestos Containing Materials (ACM's).	for a	
☐ I do not know if an asl	pestos inspection has been co	onducted on this property.		
☐ An asbestos inspectio	n has been conducted on this	s property on or about (enter date)		
☐ An asbestos inspectio	n has not been conducted on	this property.		
		tion and state that the above information is correct and agr Collins ordinances and state laws regulating building construc		
Applicant Signature		Type or Print Name		
Phone #	/ Fmail			

THIS APPLICATION EXPIRES 180 DAYS FROM APPLICATION DATE

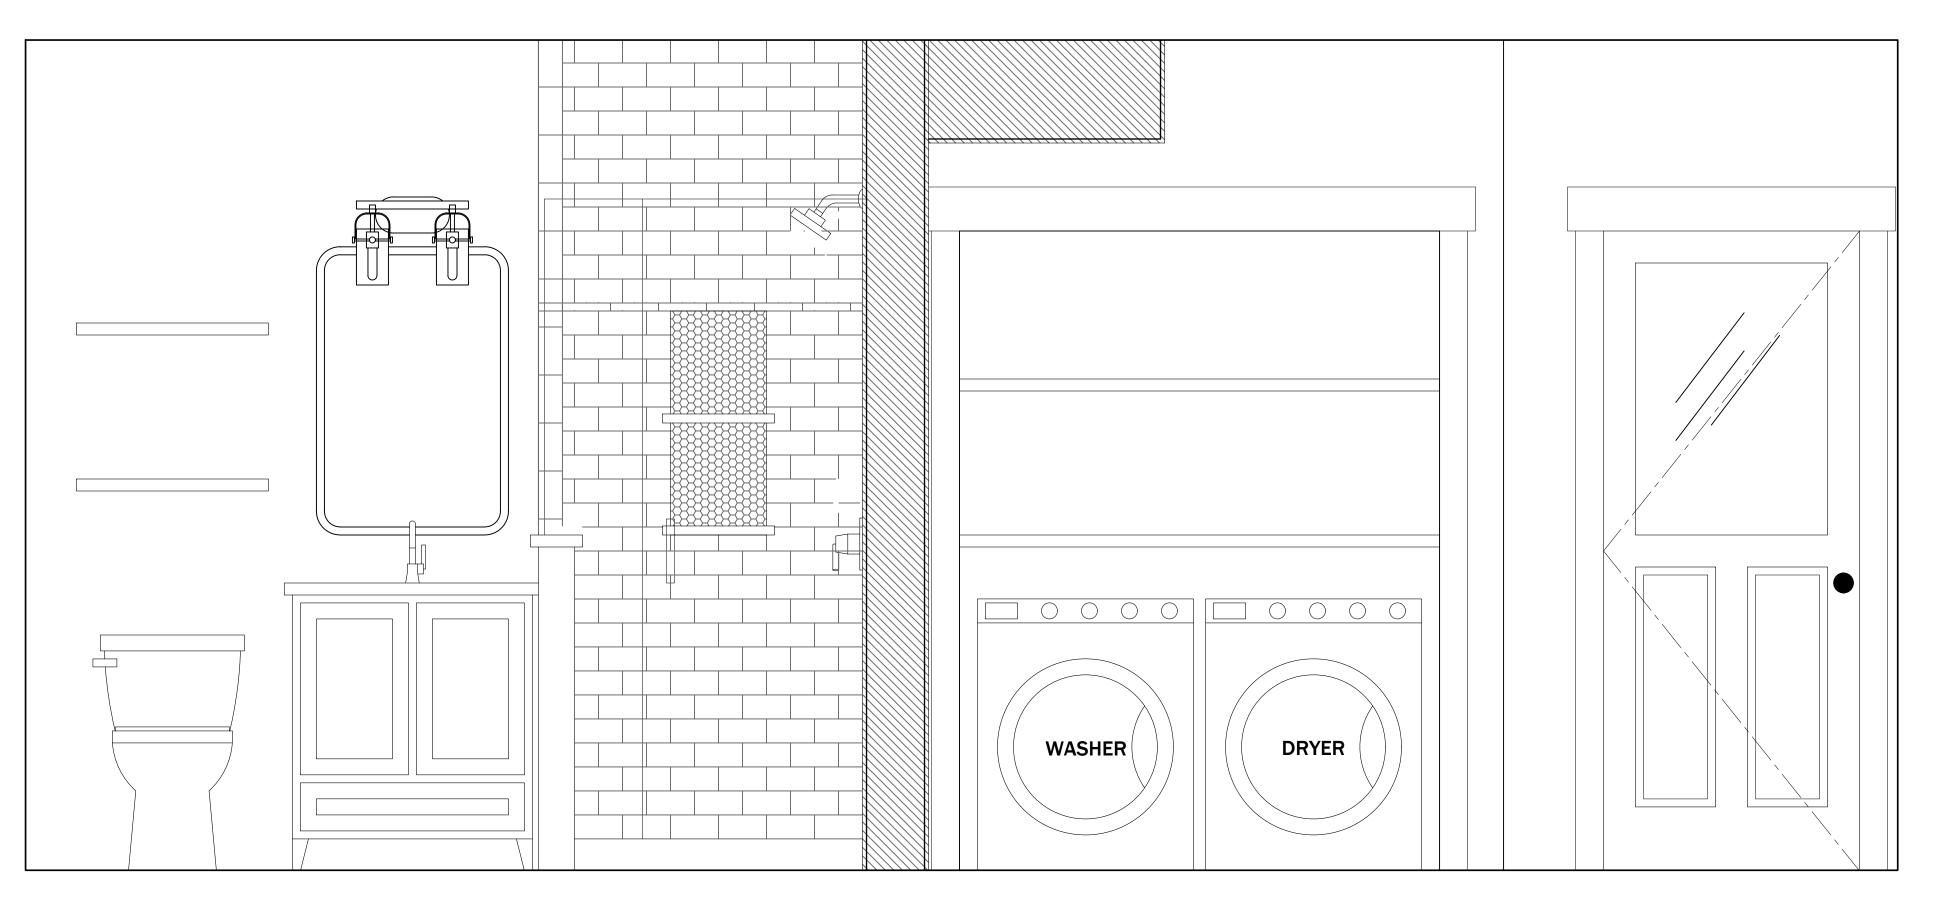


IMAGE SHOWS DESIGN INTENT ONLY, DO NOT USE FOR CONSTRUCTION

PROJECT DESCRIPTION

DESIGN and CONSTRUCTION of a REMODEL at 632 PETERSON ST. FORT COLLINS, CO 80524

GENERAL NOTES:

ENERGY CODE COMPLIANCE

CODE: 2021 IECC ZONE 5b **CLIMATE ZONE: FORCED AIR HEAT SOURCE:** R-60 MIN. **R-VALUE CEILINGS:** R-VALUE UNVENTED VAULTED CEILINGS R-30 MIN.

R-20+5CI, R-13+10CI, or R-15CI MIN. R-VALUE EXTERIOR WALLS: R-30 MIN. R-VALUE FLOORS:

R-19, R15CI, or R-13+5CI MIN. R-VALUE CRAWL/BASEMENT WALLS:

U-FACTOR DOORS:

U-.30 MIN. U-.30 MIN.

U-FACTOR WINDOWS:

DESIGN CRITERIA

2021 IRC CODE: **OCCUPANCY:** SINGLE FAMILY

REMODELED BASEMENT **SQUARE FOOTAGE:** 589 sf REMODELED UPPER BATH

51 sf TOTAL CONDITIONED 640 sf

LIST OF DRAWINGS

A.1 COVER SHEET

A.2 EXISTING BASEMENT FLOOR PLAN

A.3 BASEMENT DEMOLITION PLAN

A.4 NEW BASEMENT FLOOR PLAN

BASEMENT SECTIONS A&B BASEMENT SECTIONS C&D

EXISTING UPPER BATH FLOOR PLAN

A.8 UPPER BATH DEMOLITION PLAN

A.9 NEW UPPER BATH FLOOR PLAN

E.1 EXISTING BASEMENT ELECTRICAL PLAN

E.2 NEW BASEMENT ELECTRICAL PLAN E.3 EXISTING UPPER BATH ELECTRICAL PLAN

E.4 NEW UPPER BATH ELECTRICAL PLAN

F.1 BASEMENT FLOORING LAYOUT DIAGRAM

BASEMENT INTERIOR ELEVATIONS


F.3 UPPER BATH INTERIOR ELEVATIONS

F.4 MISC INTERIOR ELEVATIONS

ABBREVIATIONS

AFF ARCH	ABOVE FINISH FLOOR ARCHITECT	ID IN	INSIDE DIMENSION INCH
BO_	BOTTOM OF _	INSUL	INSULATION
BLKG	BLOCKING	INT	INTERIOR
BRG	BEARING	MFR	MANUFACTURER
CMU	CONC MASONRY UNIT	MAX	MAXIMUM
CLG	CEILING	MECH	MECHANICAL
СО	CASED OPENING	MIN	MINIMUM
COL	COLUMN	NTS	NOT TO SCALE
CONC	CONCRETE	OC	ON CENTER
CONT	CONTINUOUS	OD	OUTSIDE DIMENSION
CONST	CONSTRUCTION	OPP	OPPOSITE
D	DRYER	PL	PLATE
DIM	DIMENSION	PLYWD	PLYWOOD
DN	DOWN	PT	POINT
DR	DOOR	R	RADIUS
DS	DOWNSPOUT	RE	REFERENCE/REFER TO
DTL	DETAIL	REFR	REFRIGERATOR
DW	DISHWASHER	REINF	REINFORCED/ING
DWGS	DRAWINGS	REQD	REQUIRED
(E)	EXISTING	RM	ROOM
EA	EACH	RO	ROUGH OPENING
ELEC	ELECTRICAL	RS	ROUGH SAWN
ELEV	ELEVATION	SF	SQUARE FEET
EQ	EQUAL	SHWR	SHOWER
EQUIP	EQUIPMENT	SIM	SIMILAR
FOC	FACE OF CONCRETE	STL	STEEL
FOM	FACE OF MASONRY	STRL	STRUCTURAL
FOS	FACE OF STUD	SQ	SQUARE
FP	FIREPLACE	TBD	TO BE DETERMINED
FIN	FINISH	TF	TIMBER FRAME
FD	FLOOR DRAIN	THK	THICK
FLR	FLOOR	TO_	TOP OF _
GA	GAGE	TYP	TYPICAL
GALV	GALVANIZED	UNO	UNLESS NOTED OTHERWIS
GC	GENERAL CONTRACTOR	VERT	VERTICAL
GYP	GYPSOM BOARD	W	WASHER
G.L.	GLU-LAM	WDO	WINDOW
НВ	HOSE BIB	W/	WITH
HDWR	HARDWARE	W/O	WITHOUT
HORIZ	HORIZONTAL	۷	ANGLE
HR	HOUR	Ø	DIAMETER
		<u>E</u>	CENTERLINE

DESIGN . BUILD **ELEVATED DESIGN BUILD** 144 RACQUETTE DR FORT COLLINS, CO 80524

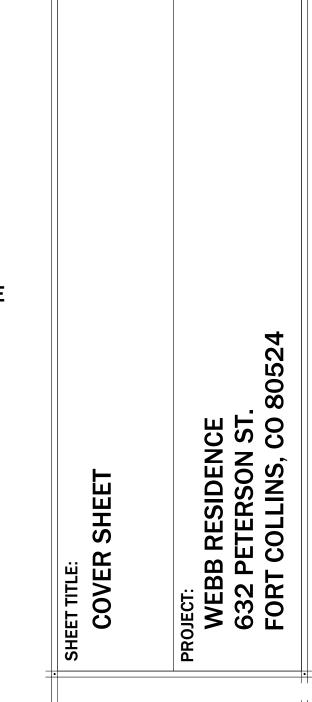

ISSUE SET:

DRAWING DATE:

DRAWN BY:

FILE NAME:

SCALE:

REVISIONS: DATE:

PERMIT SET

6/25/2024

Webb-Permit Set-

4.30.24

CHECKED BY:

DK

ENGINEER ARCHITECTURAL DESIGN

Elevated Design Build 144 Racquette Dr.

Fort Collins, CO 80524 (970) 682-8363

Dave@elevateddesignbuild.com **Email:**

Dave Kaplan **Contact:**

GENERAL CONTRACTOR

Elevated Design Build 144 Racquette Dr. Fort Collins, CO 80524 (970) 682-8363 Phone: Dave@elevateddesignbuild.com Email:

Contact: Dave Kaplan


OWNER


N/A

Colleen Webb 632 Peterson St. Fort Collins, CO 80524 Phone: (970) 402-5880


Email: colleen.webb@colostate.edu


N/A SHEET NO:

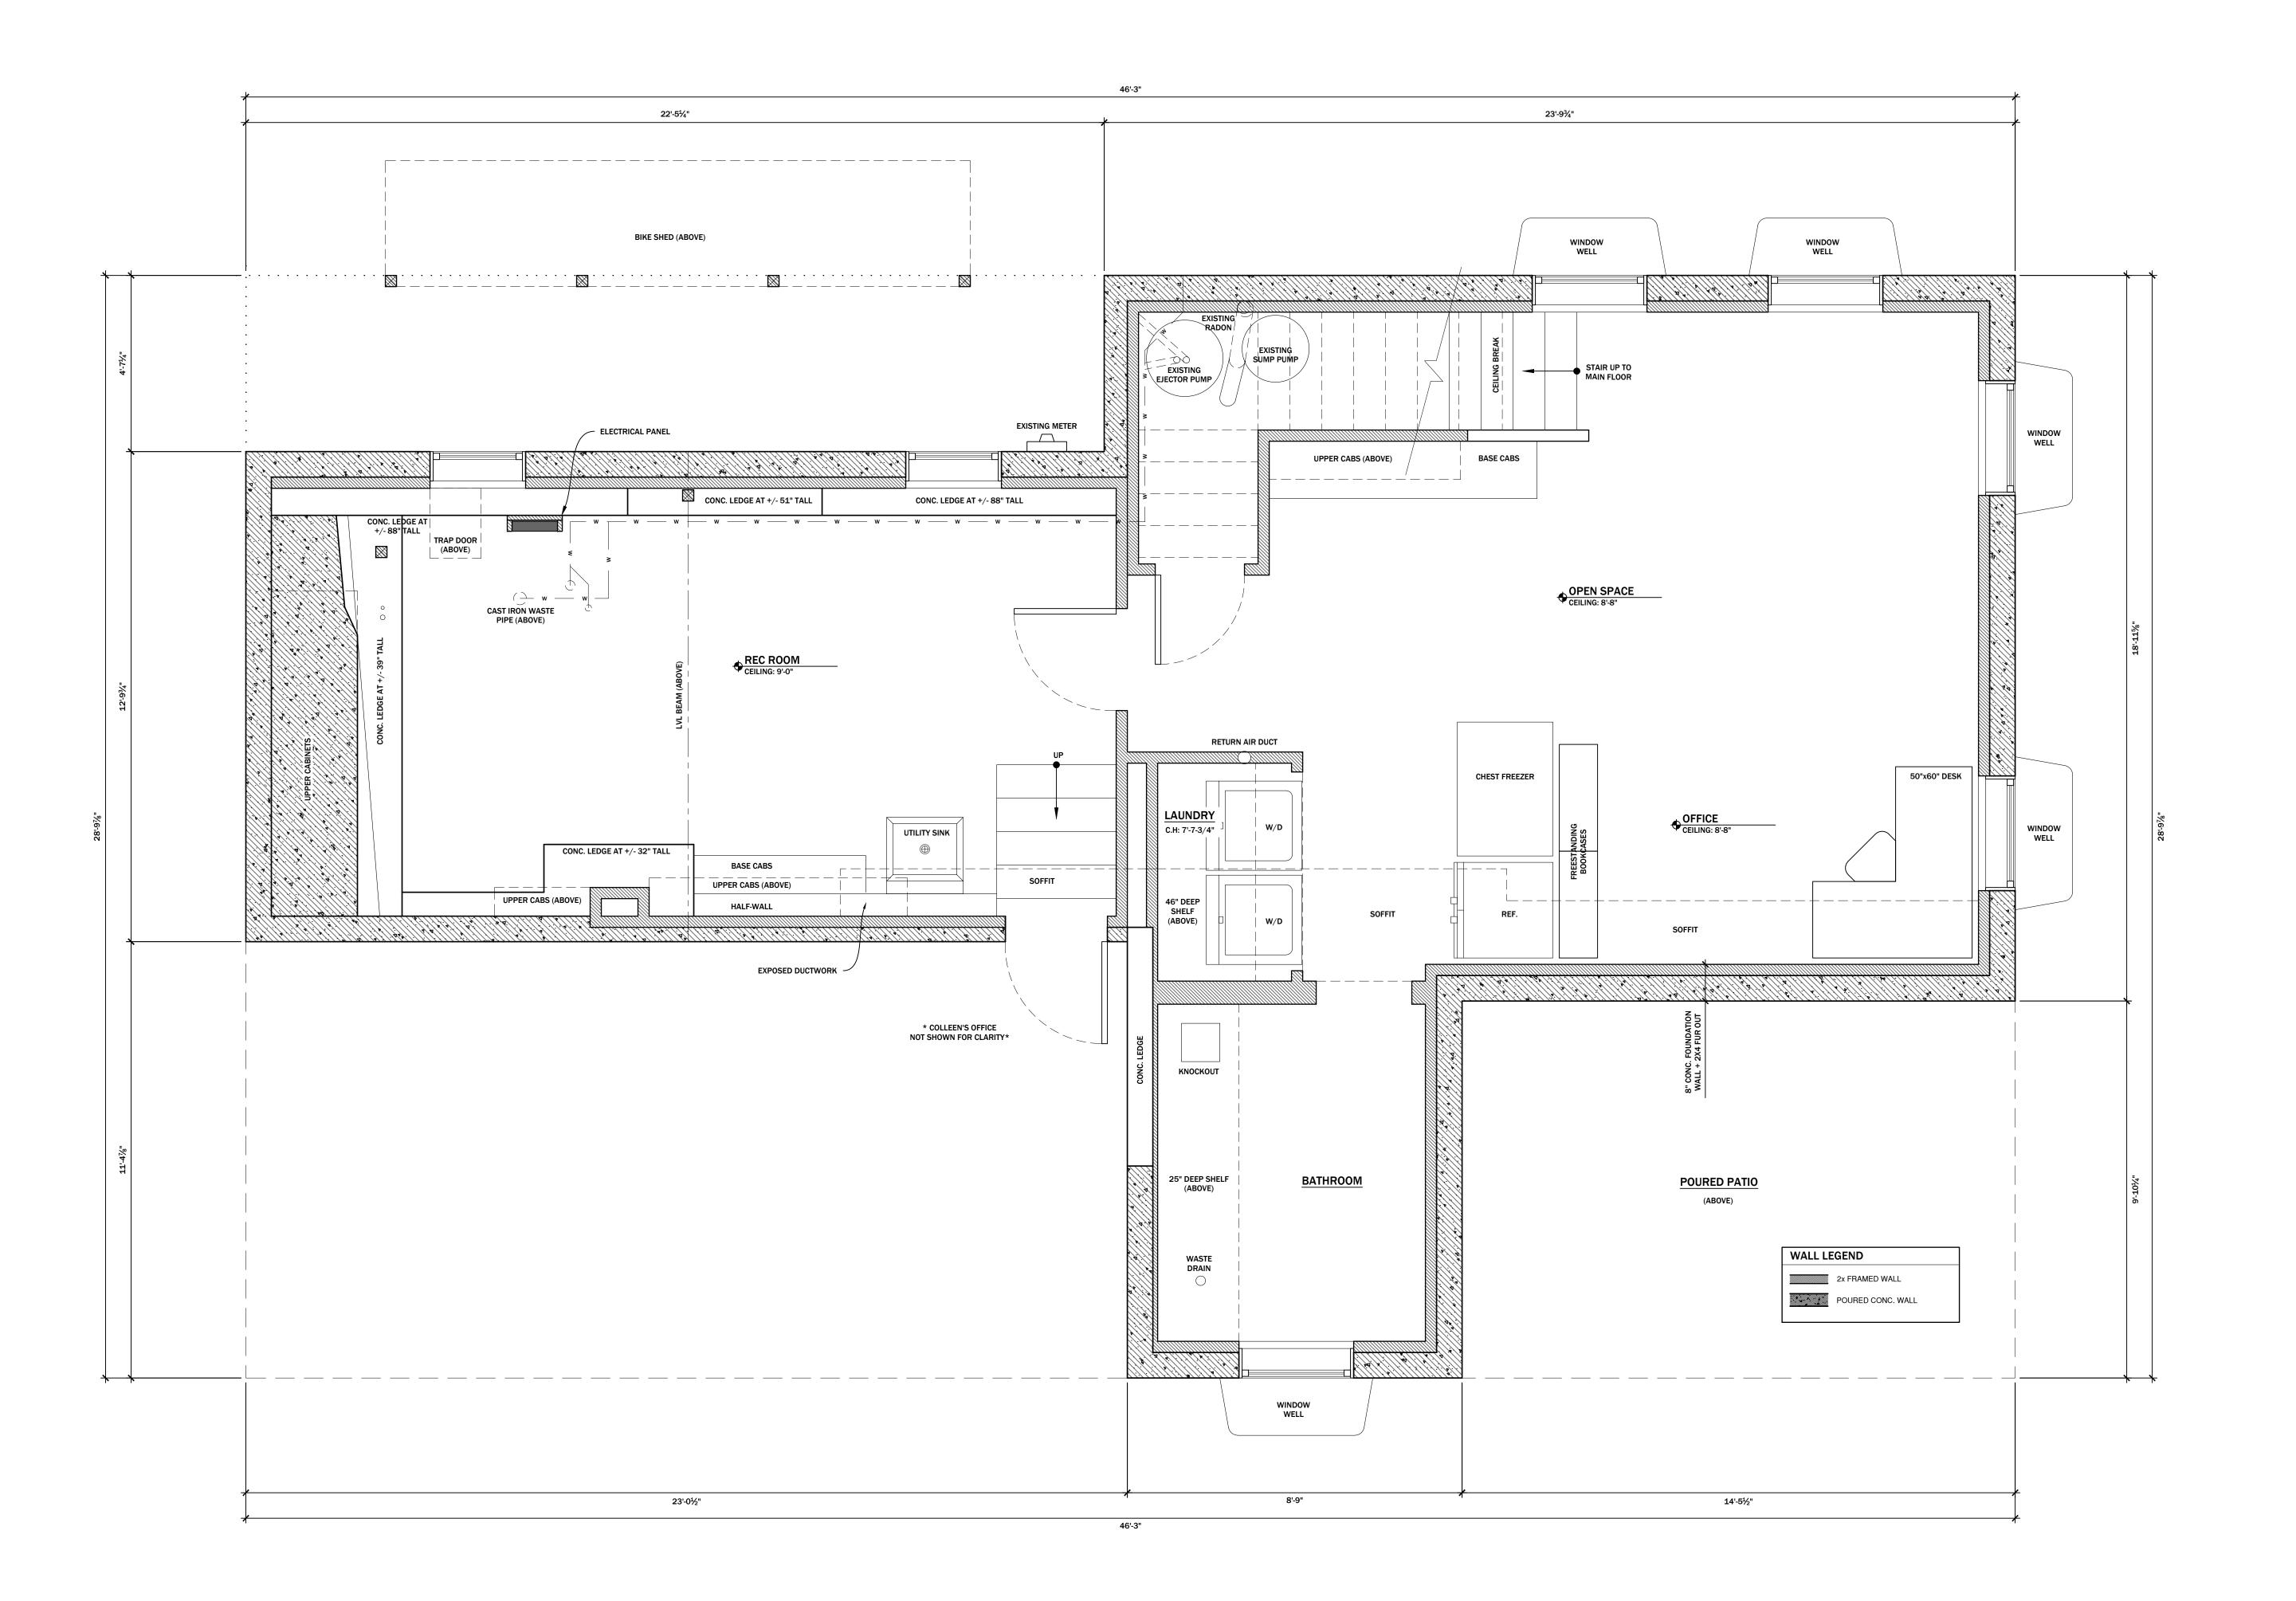

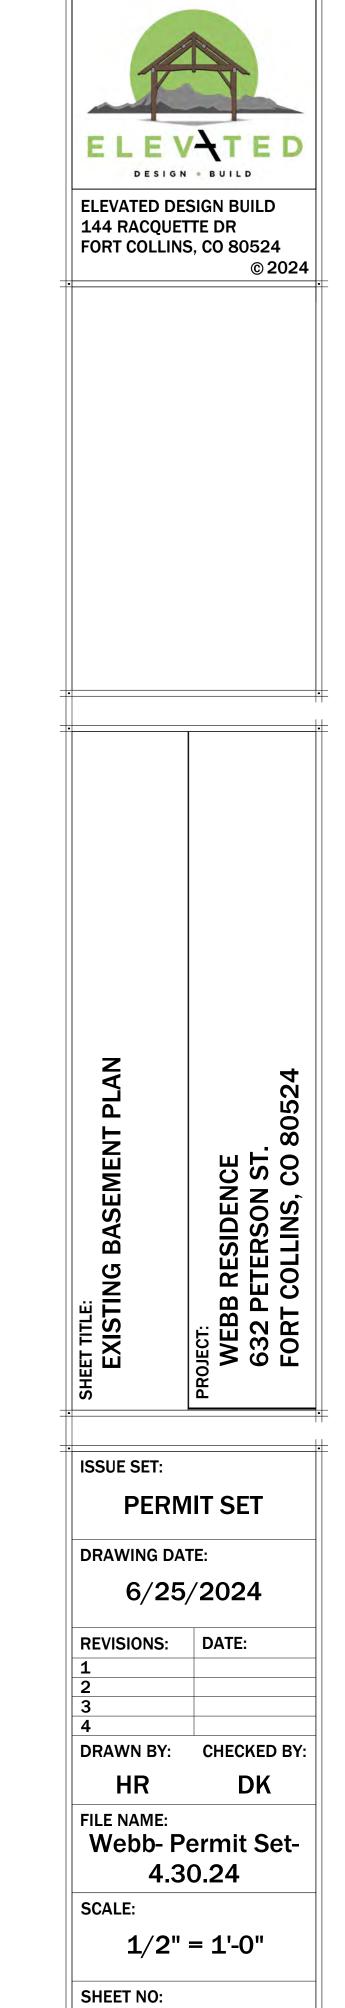



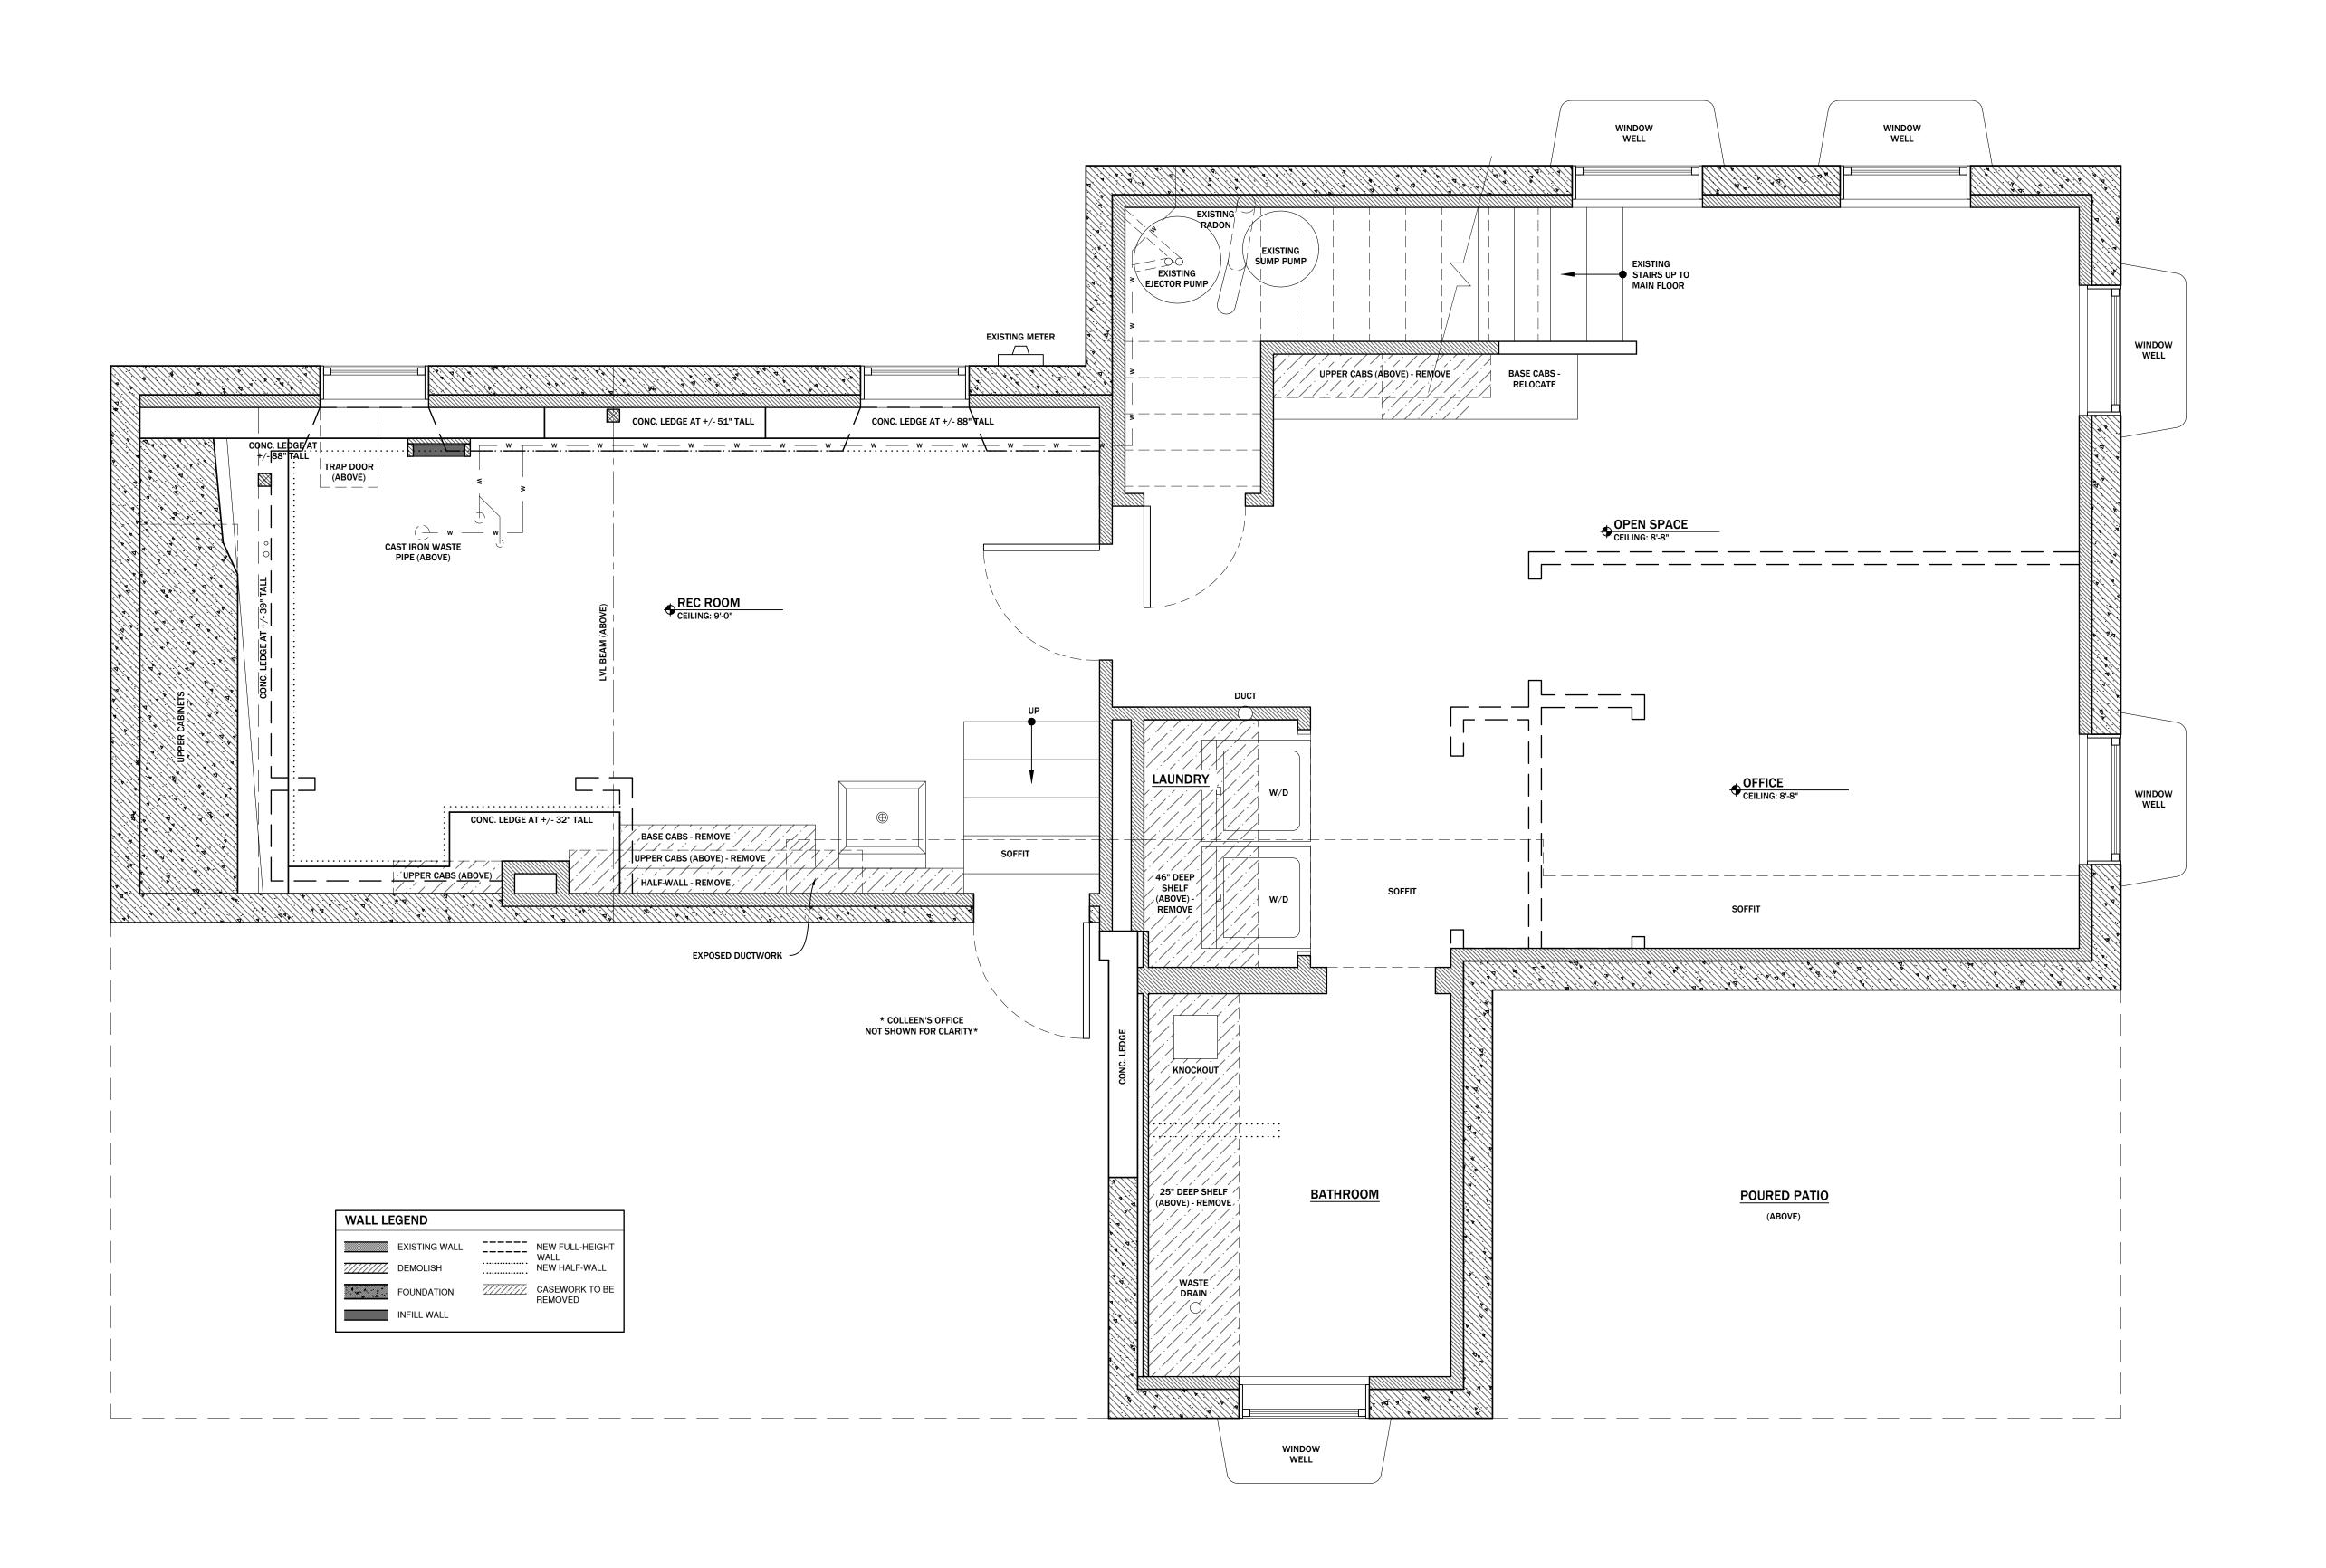


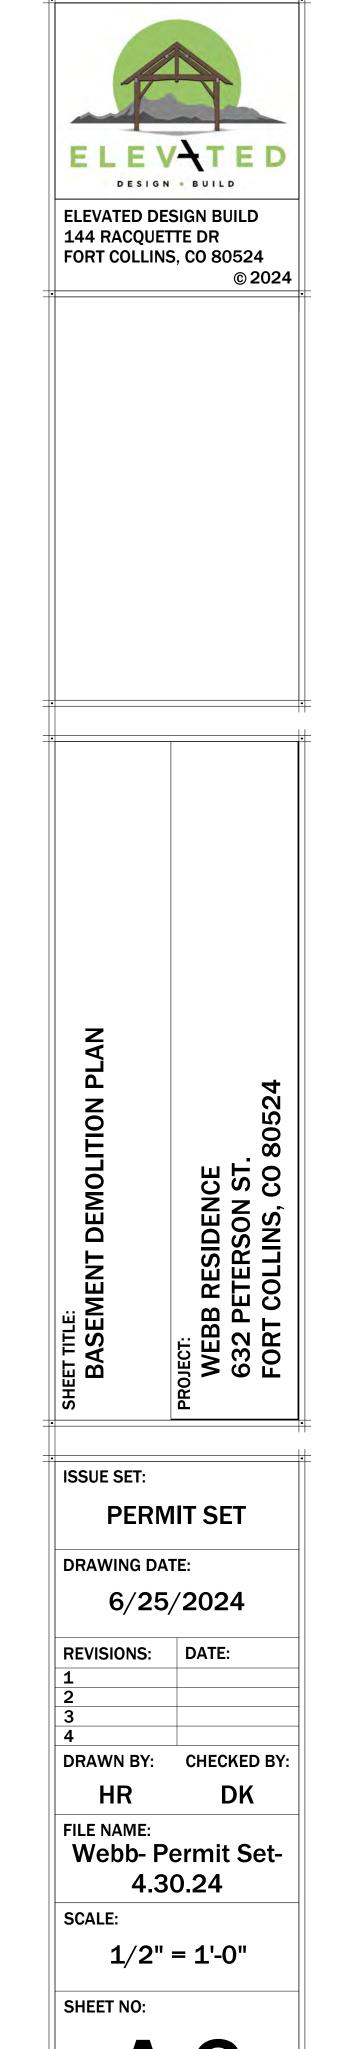


SCALE: 1/2" = 1'-0"

BASEMENT DEMOLITION PLAN

SCALE: 1/2" = 1'-0"

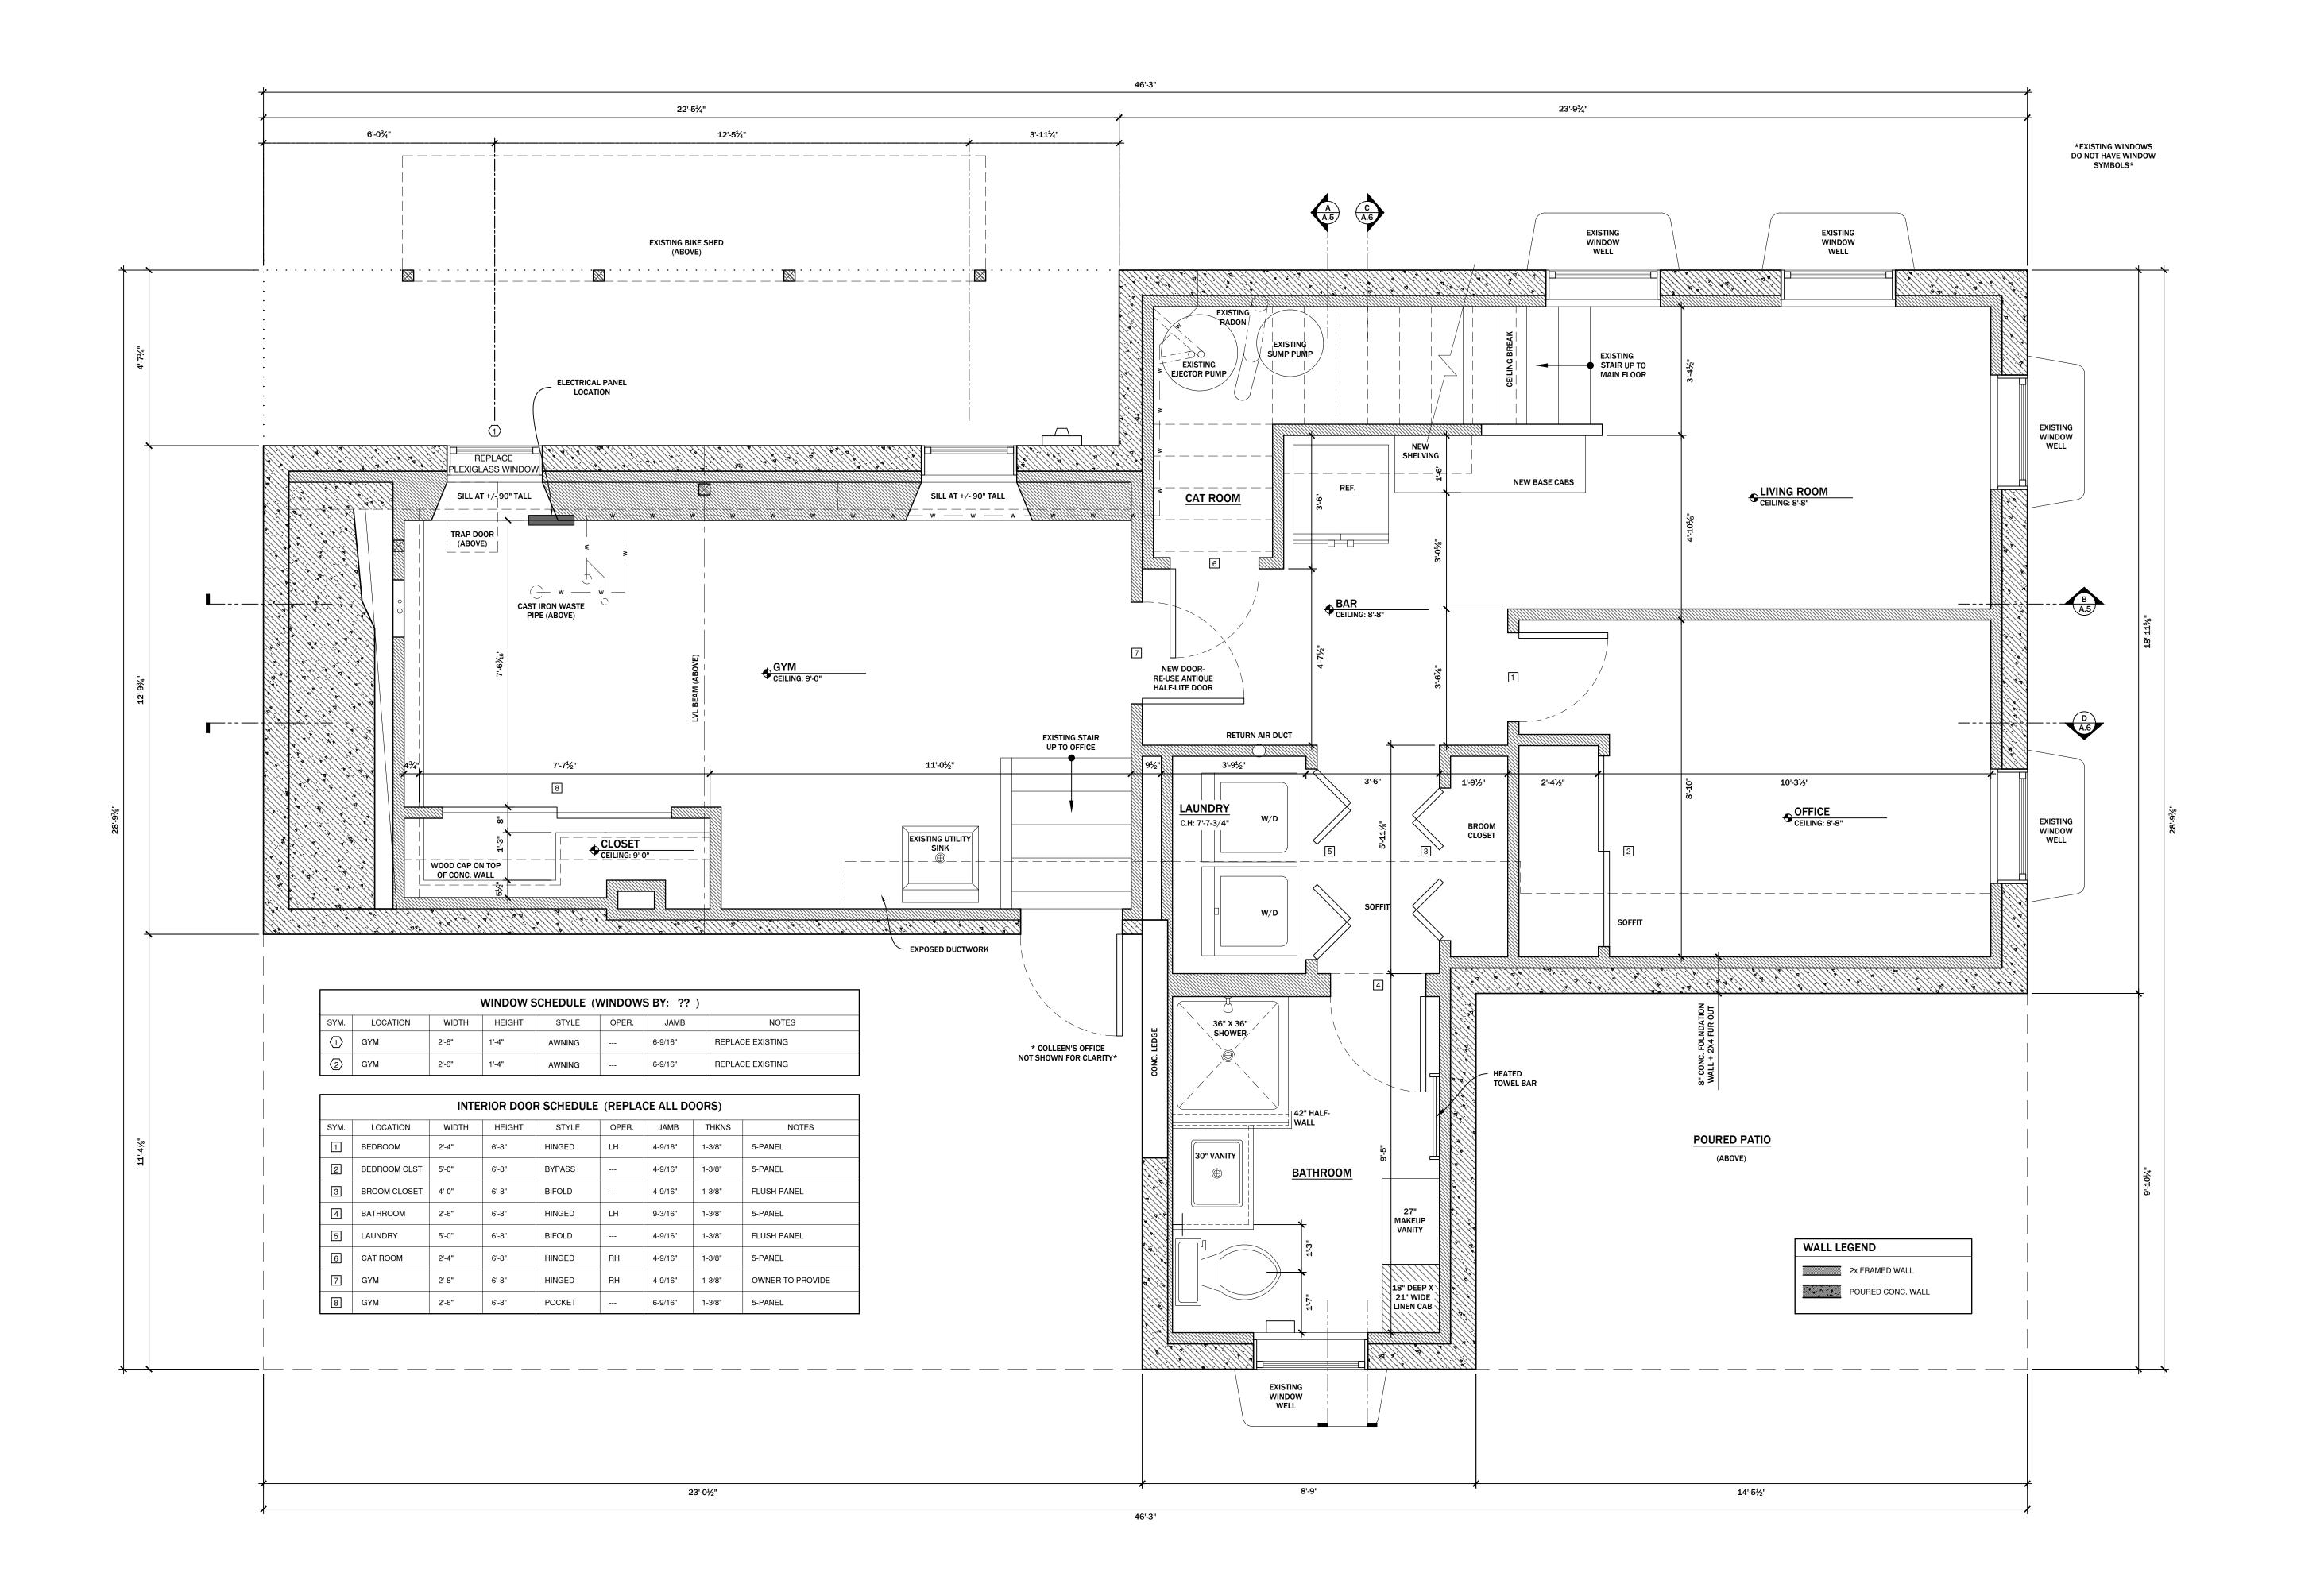

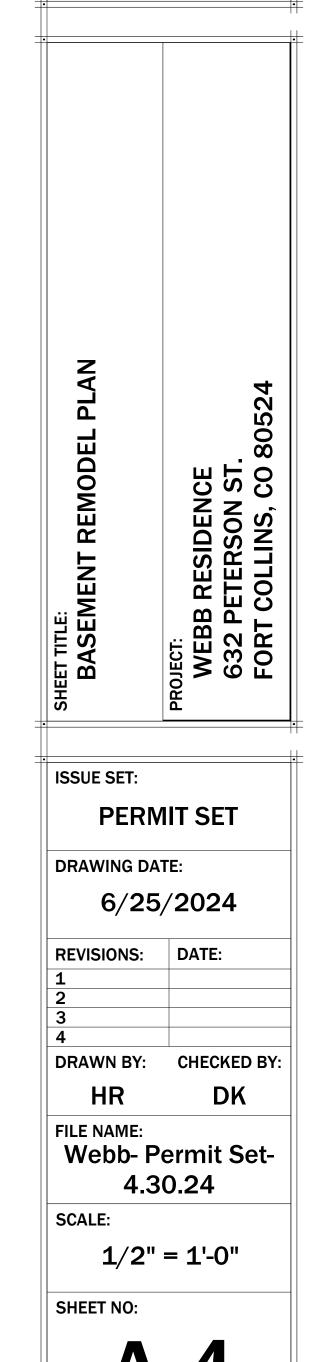


DESIGN . BUILD


ELEVATED DESIGN BUILD

FORT COLLINS, CO 80524

144 RACQUETTE DR



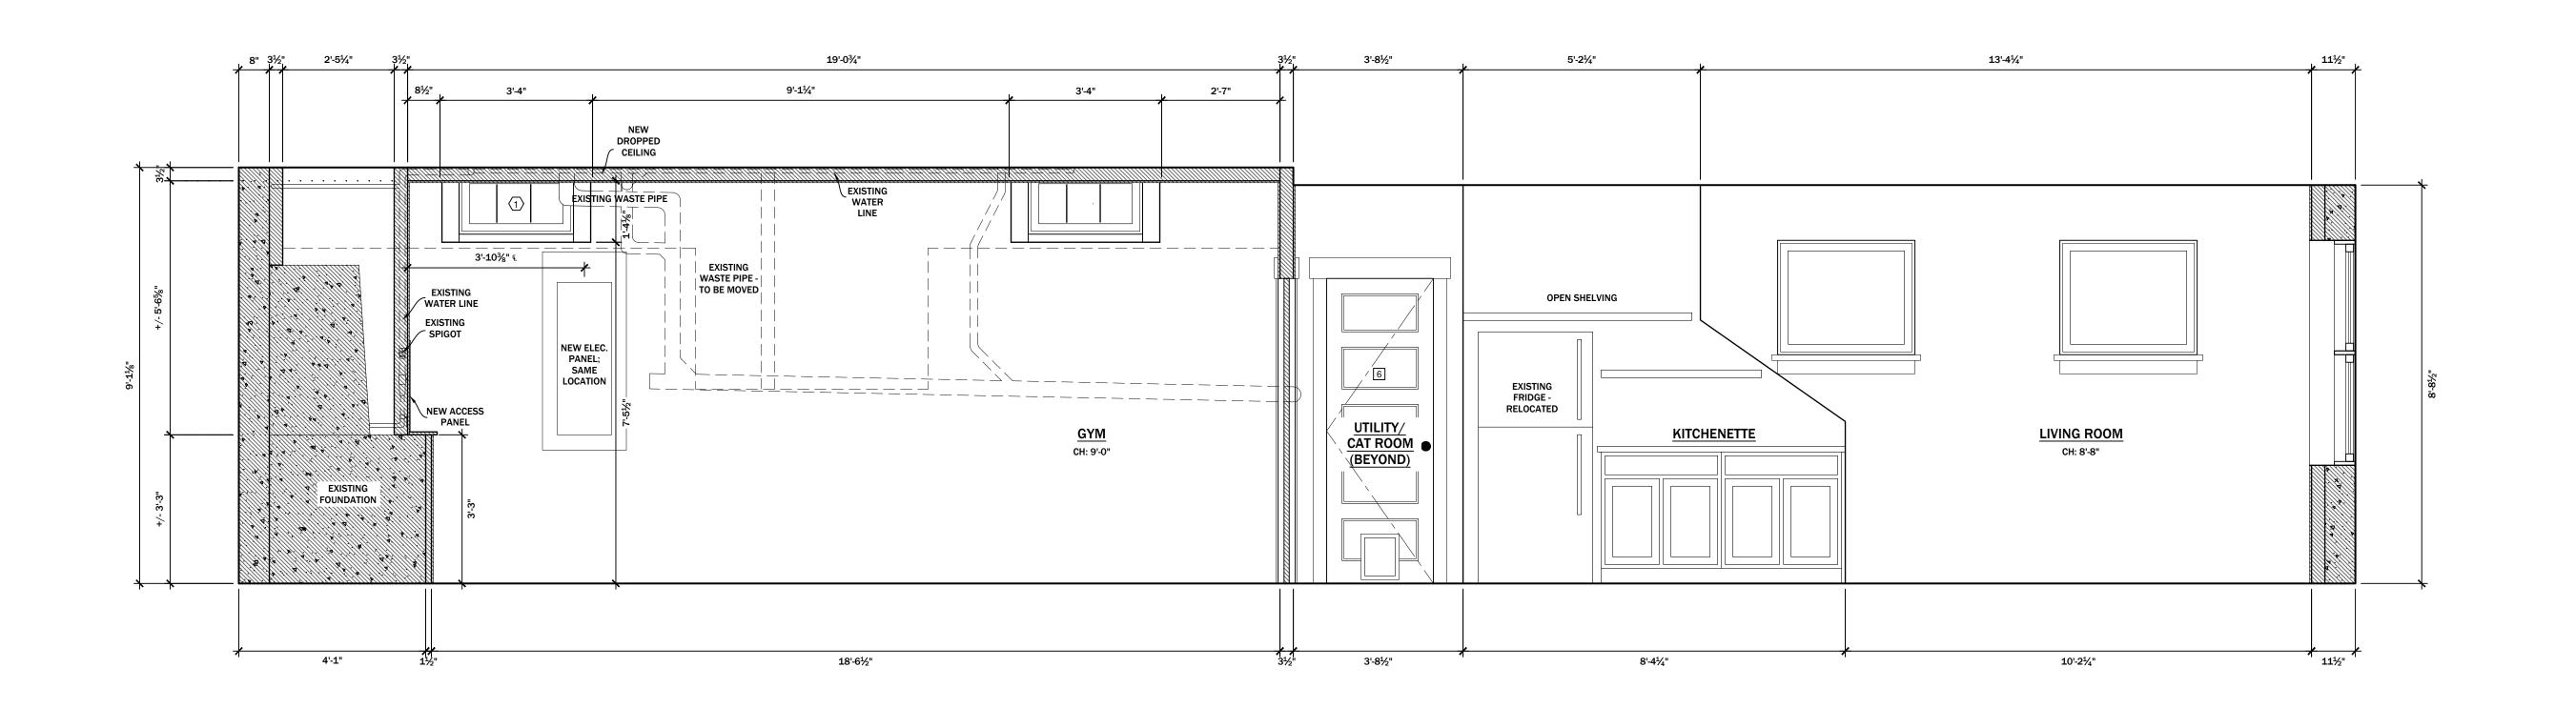

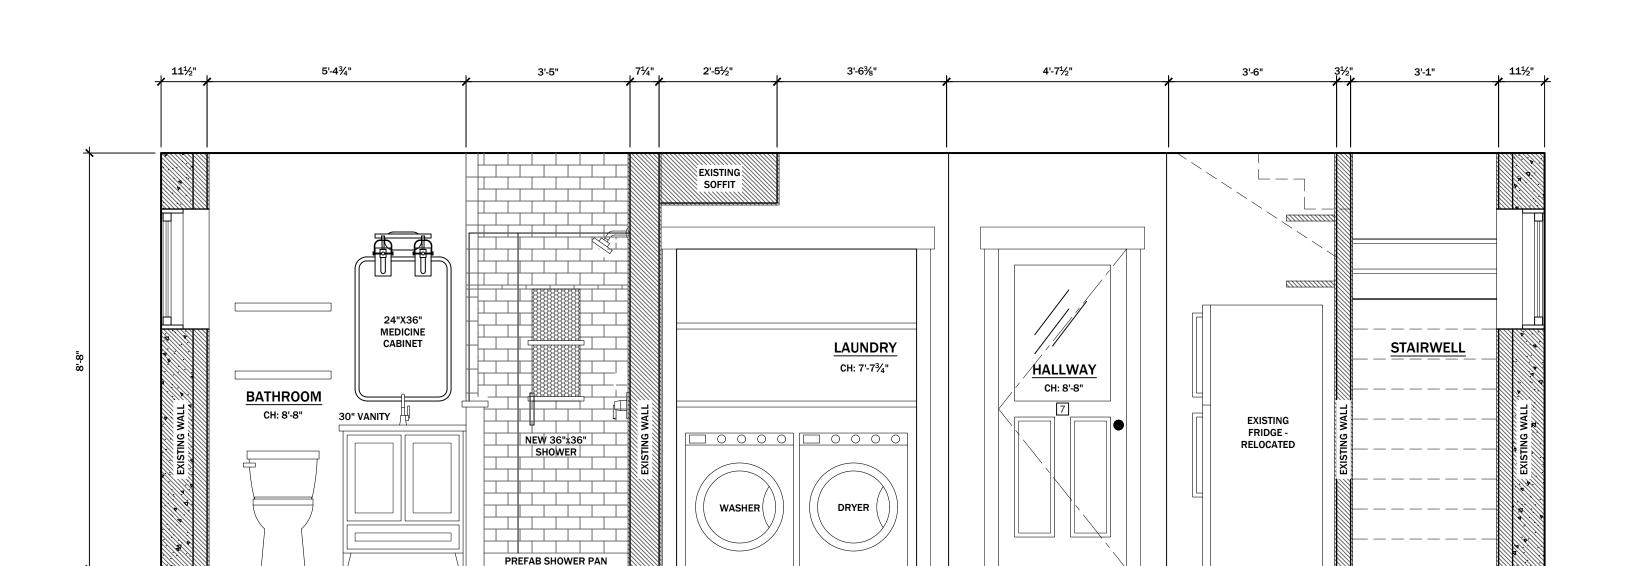




SECTION B


SCALE: 1/2" = 1'-0"

SCALE: 1/2" = 1'-0"

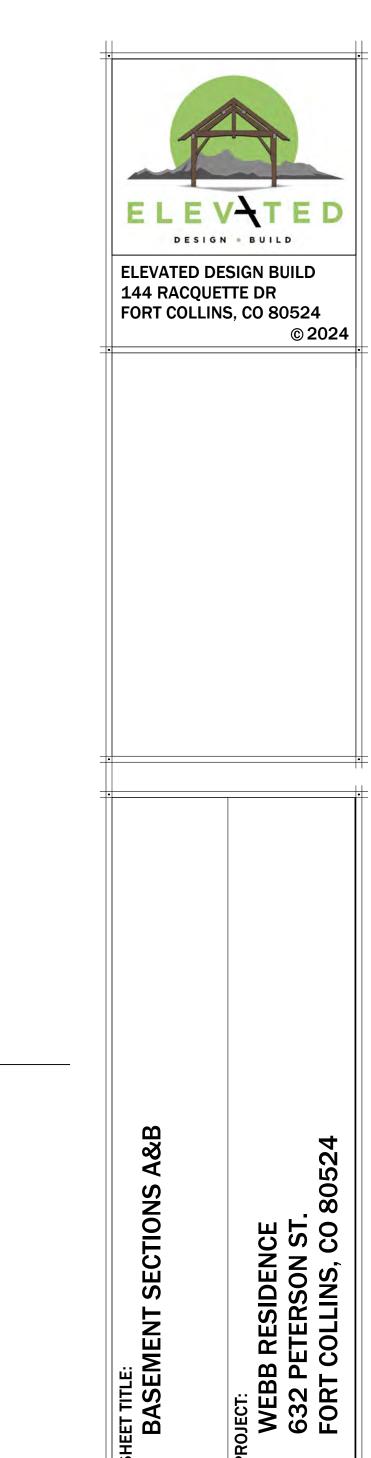


S	<u> </u>		
ISSUE SET:			
PERMIT SET			
DRAWING DA	TE:		
6/25	/2024		
REVISIONS:	DATE:		
1			
2 3 4			
4			
DRAWN BY:	CHECKED BY:		
HR	DK		
FILE NAME:			
Webb-P	ermit Set-		
4.30.24			
SCALE:			
1/2" = 1'-0"			
SHEET NO:			

A.5 5 of 13

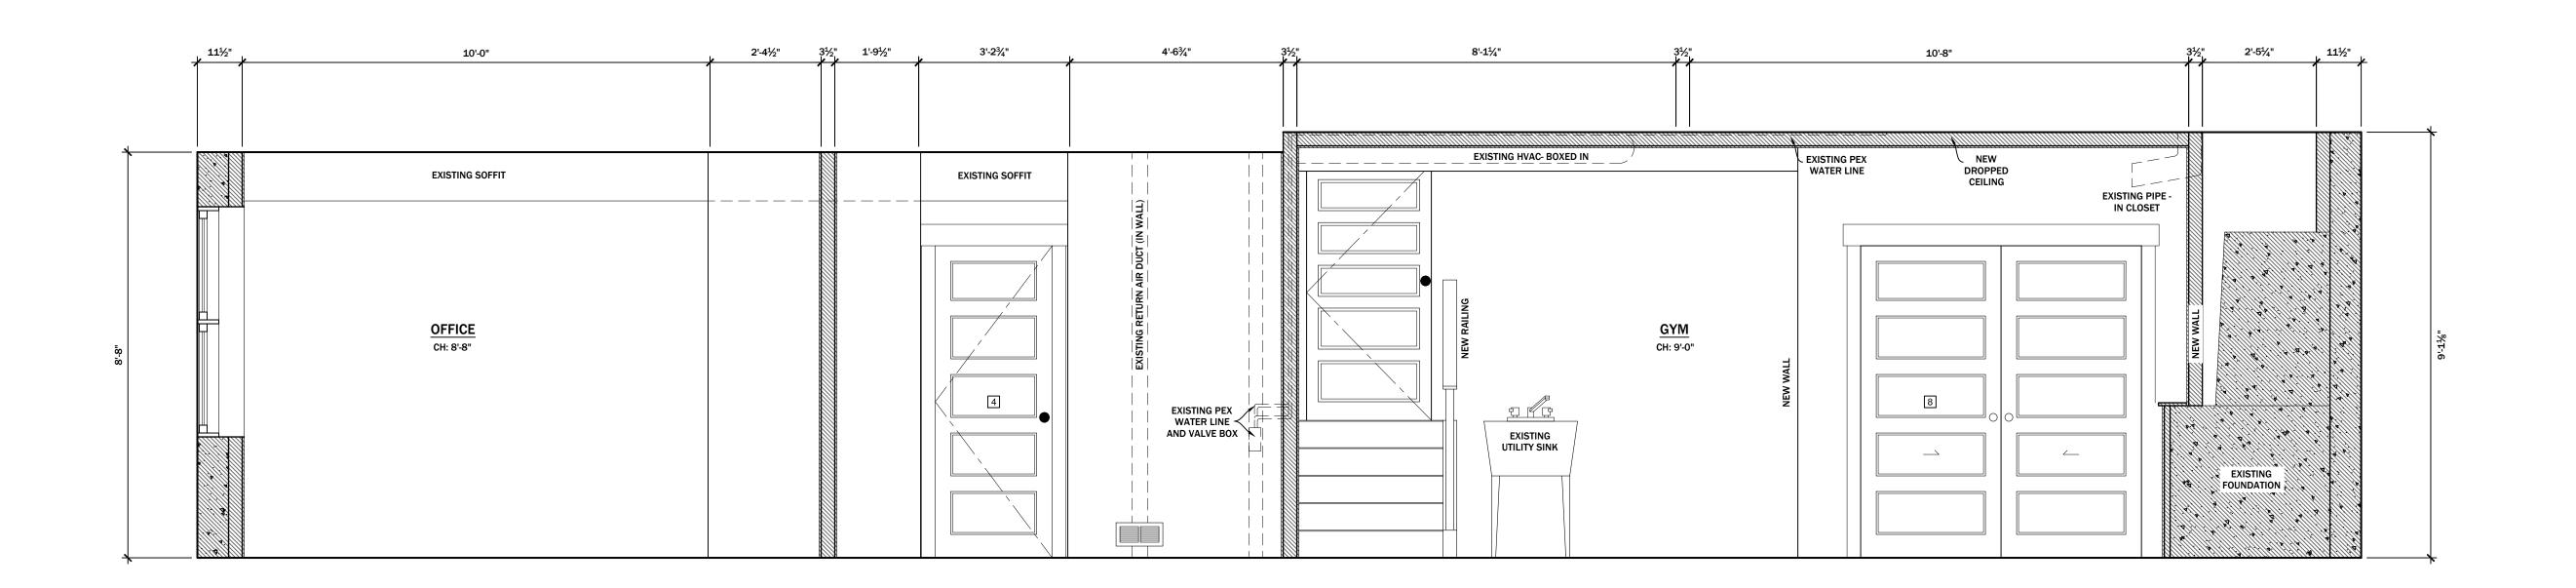

SECTION D

SCALE: 1/2" = 1'-0"

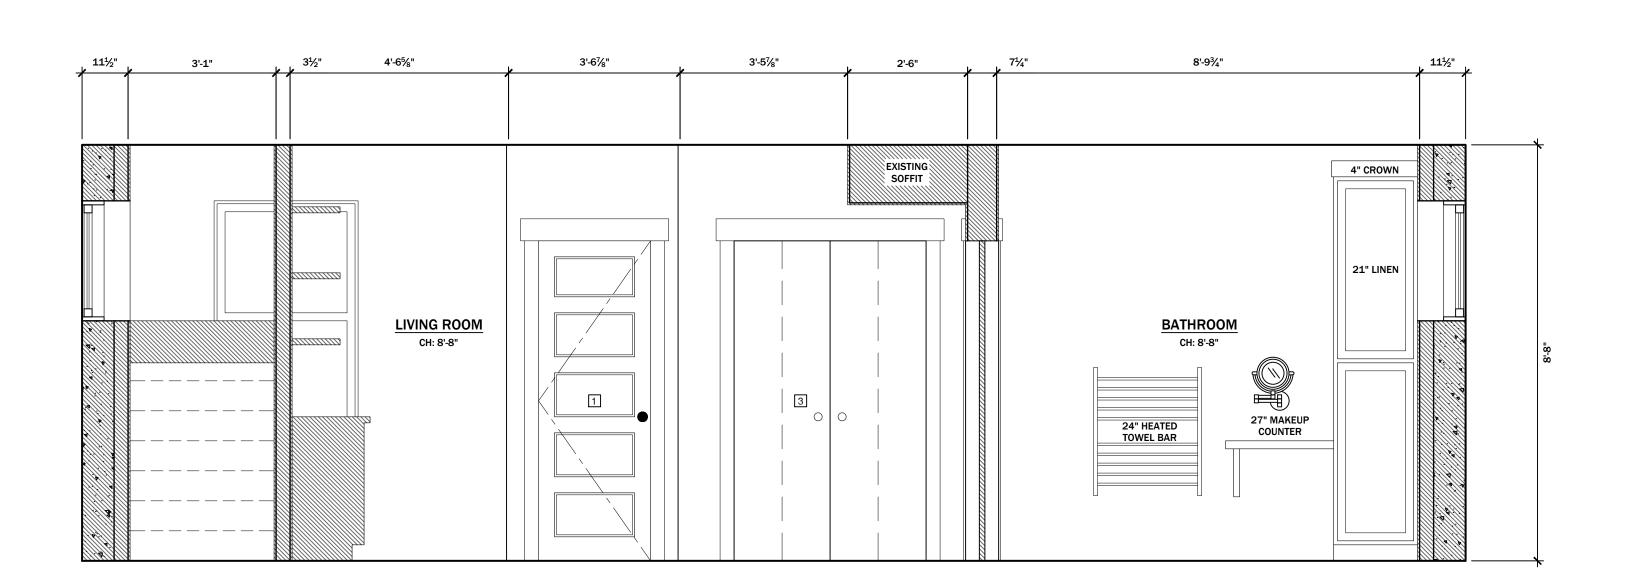

SECTION CSCALE: 1/2" = 1'-0"

ELEVATED

ELEVATED DESIGN BUILD

144 RACQUETTE DR

FORT COLLINS, CO 80524

© 2024


3&D				70
BASEMENT SECTIONS C&D	PROJECT:	WEBB RESIDENCE	632 PETERSON ST.	LCADA CO SINI IOO TOOS

- ,		
ISSUE SET:		
PERM	IT SET	
DRAWING DAT	ΓE:	
6/25/	/2024	
REVISIONS:	DATE:	
1		
2		
3		
-	CHECKED BY:	
HR	DK	
FILE NAME: Webb- Permit Set- 4.30.24		
SCALE:		
1/2" = 1'-0"		
SHEET NO:		
A.6		

WALL LEGEND

2x FRAMED WALL

POURED CONC. WALL

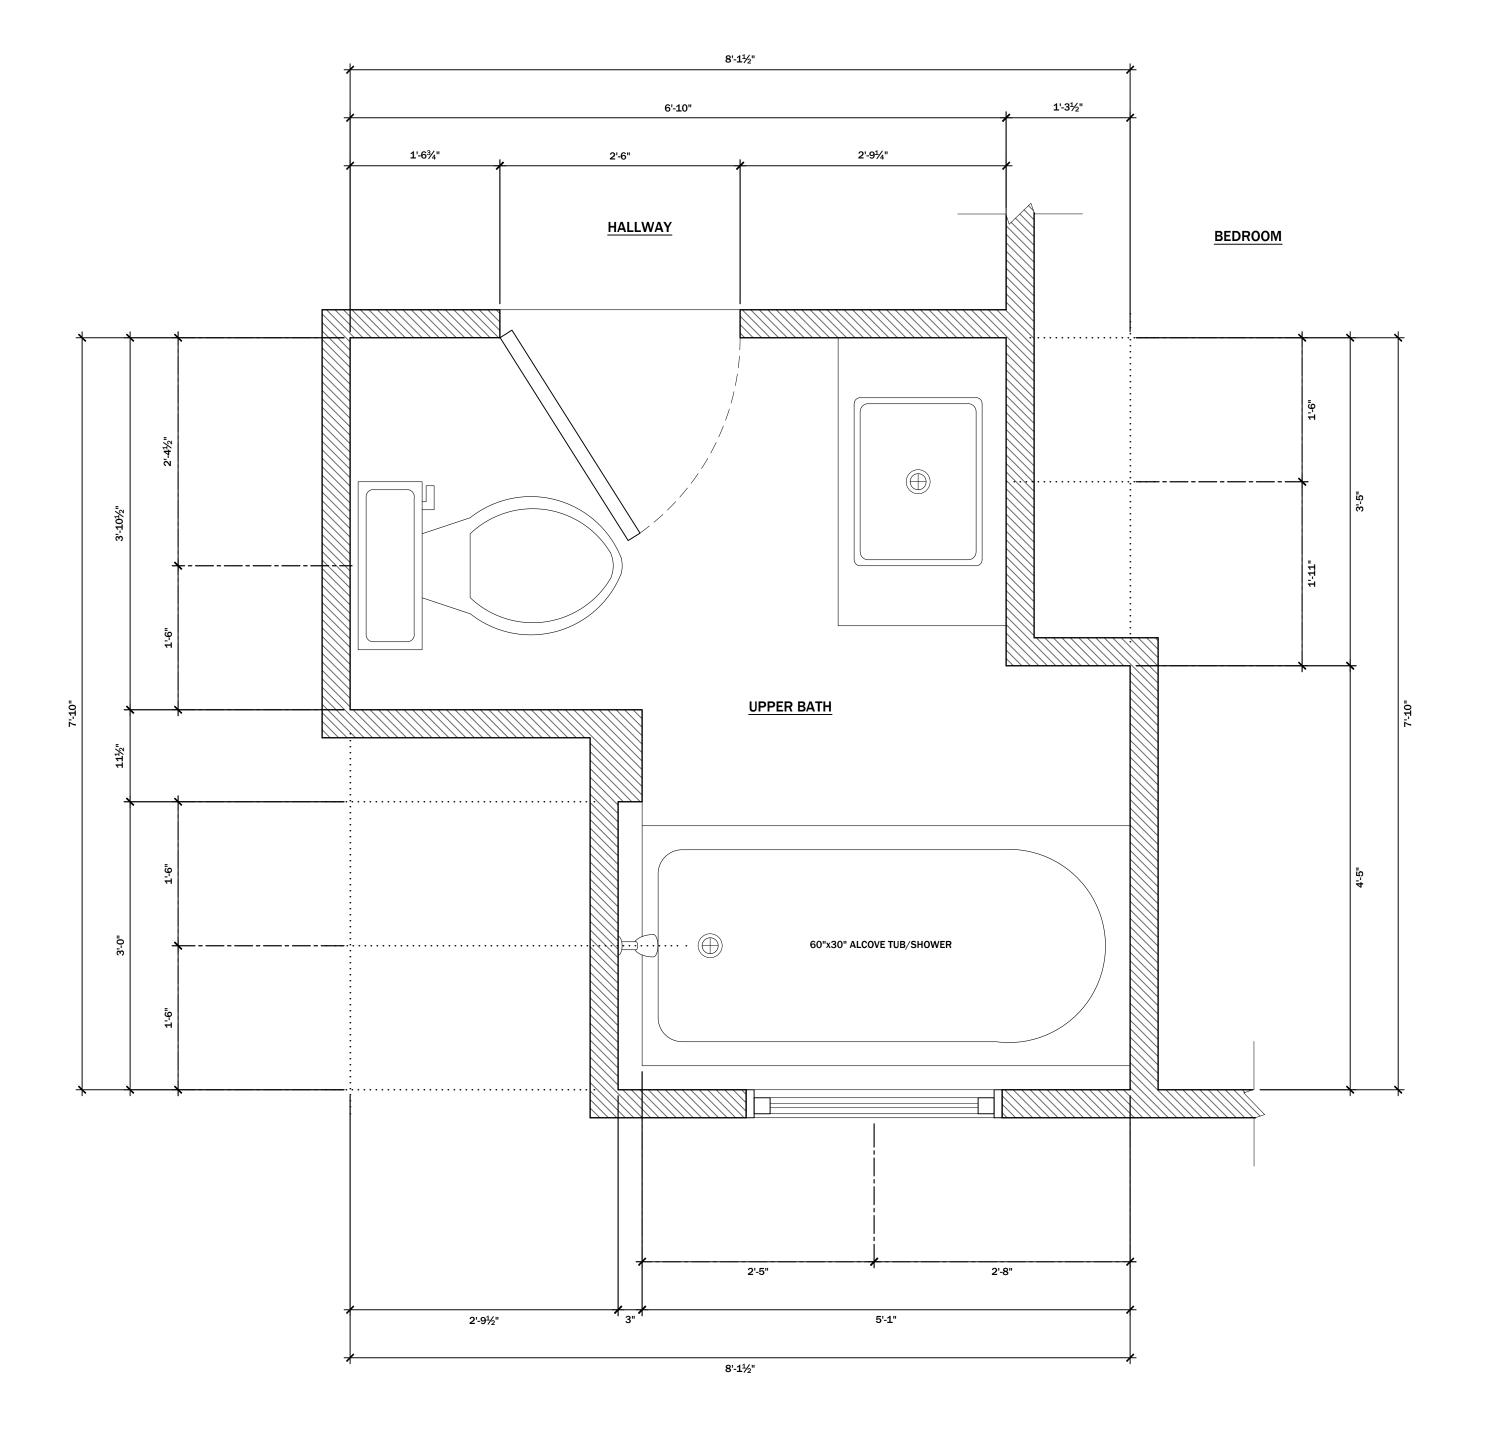



R PLAN				
SHEEL HILLE: EXISTING UPPER BATH FLOOR PLAN	PROJECT:	WEBB RESIDENCE	632 PETERSON ST.	FORT COLLINS, CO 80524

SHE	PRO
ISSUE SET:	
PERM	IIT SET
DRAWING DA	TE:
6/25	/2024
REVISIONS:	DATE:
1	
2 3 4	
4	
DRAWN BY:	CHECKED BY
HR	DK
	ermit Set- 0.24
SCALE:	
1" =	1'-0"
SHEET NO:	
Δ	7


7 of 13


UPPER BATH EXISTING FLOOR

PLAN

SCALE: 1" = 1'-0"

BATH

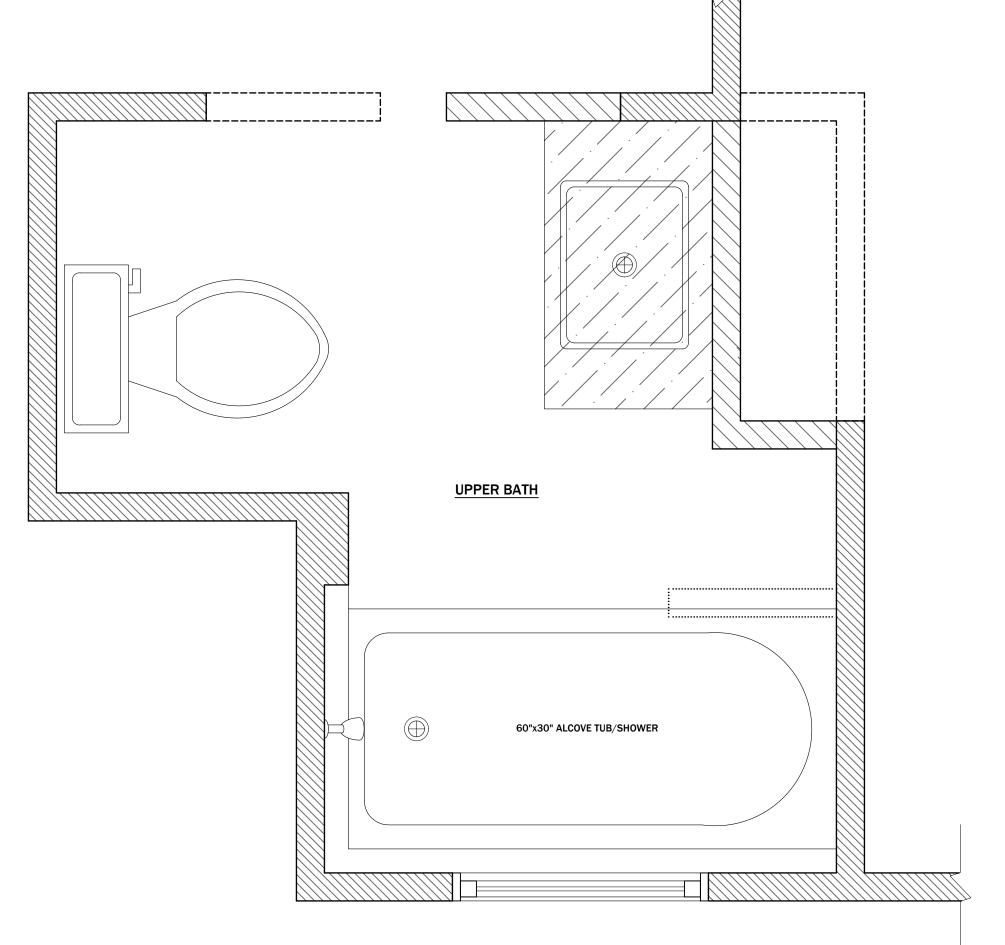

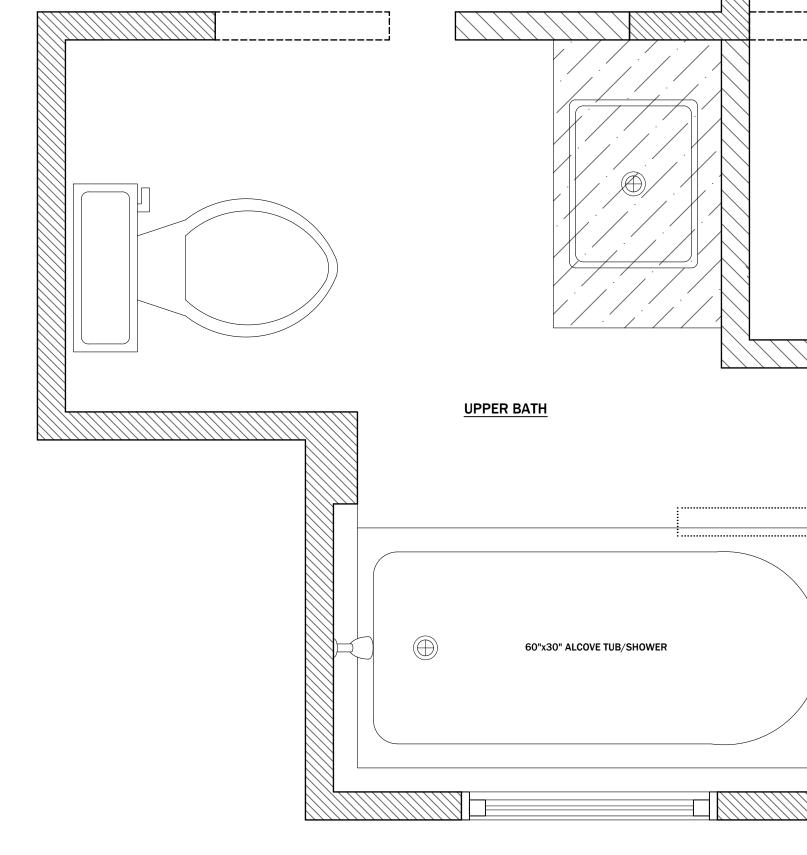

WALL LEGEND

______DEMOLISH

FOUNDATION

INFILL WALL

EXISTING WALL

NEW FULL-HEIGHT

CASEWORK TO BE REMOVED

NEW HALF-WALL




H DEMO PLAN	DENCE SON ST. NS, CO 80524
SHEET TITLE: UPPER BATH DEMO PLAN	PROJECT: WEBB RESIDENCE 632 PETERSON ST. FORT COLLINS, CO 80524

ISSUE SET:		
PERMIT SET		
DRAWING DA	TE:	
6/25	/2024	
REVISIONS:	DATE:	
1		
2		
2 3 4		
DRAWN BY:	CHECKED BY:	
HR	DK	
FILE NAME:		
Webb-P	ermit Set-	
4.30.24		
SCALE:		
1" = 1'-0"		
SHEET NO:		
A	.8	

WALL LEGEND


2x FRAMED WALL

POURED CONC. WALL

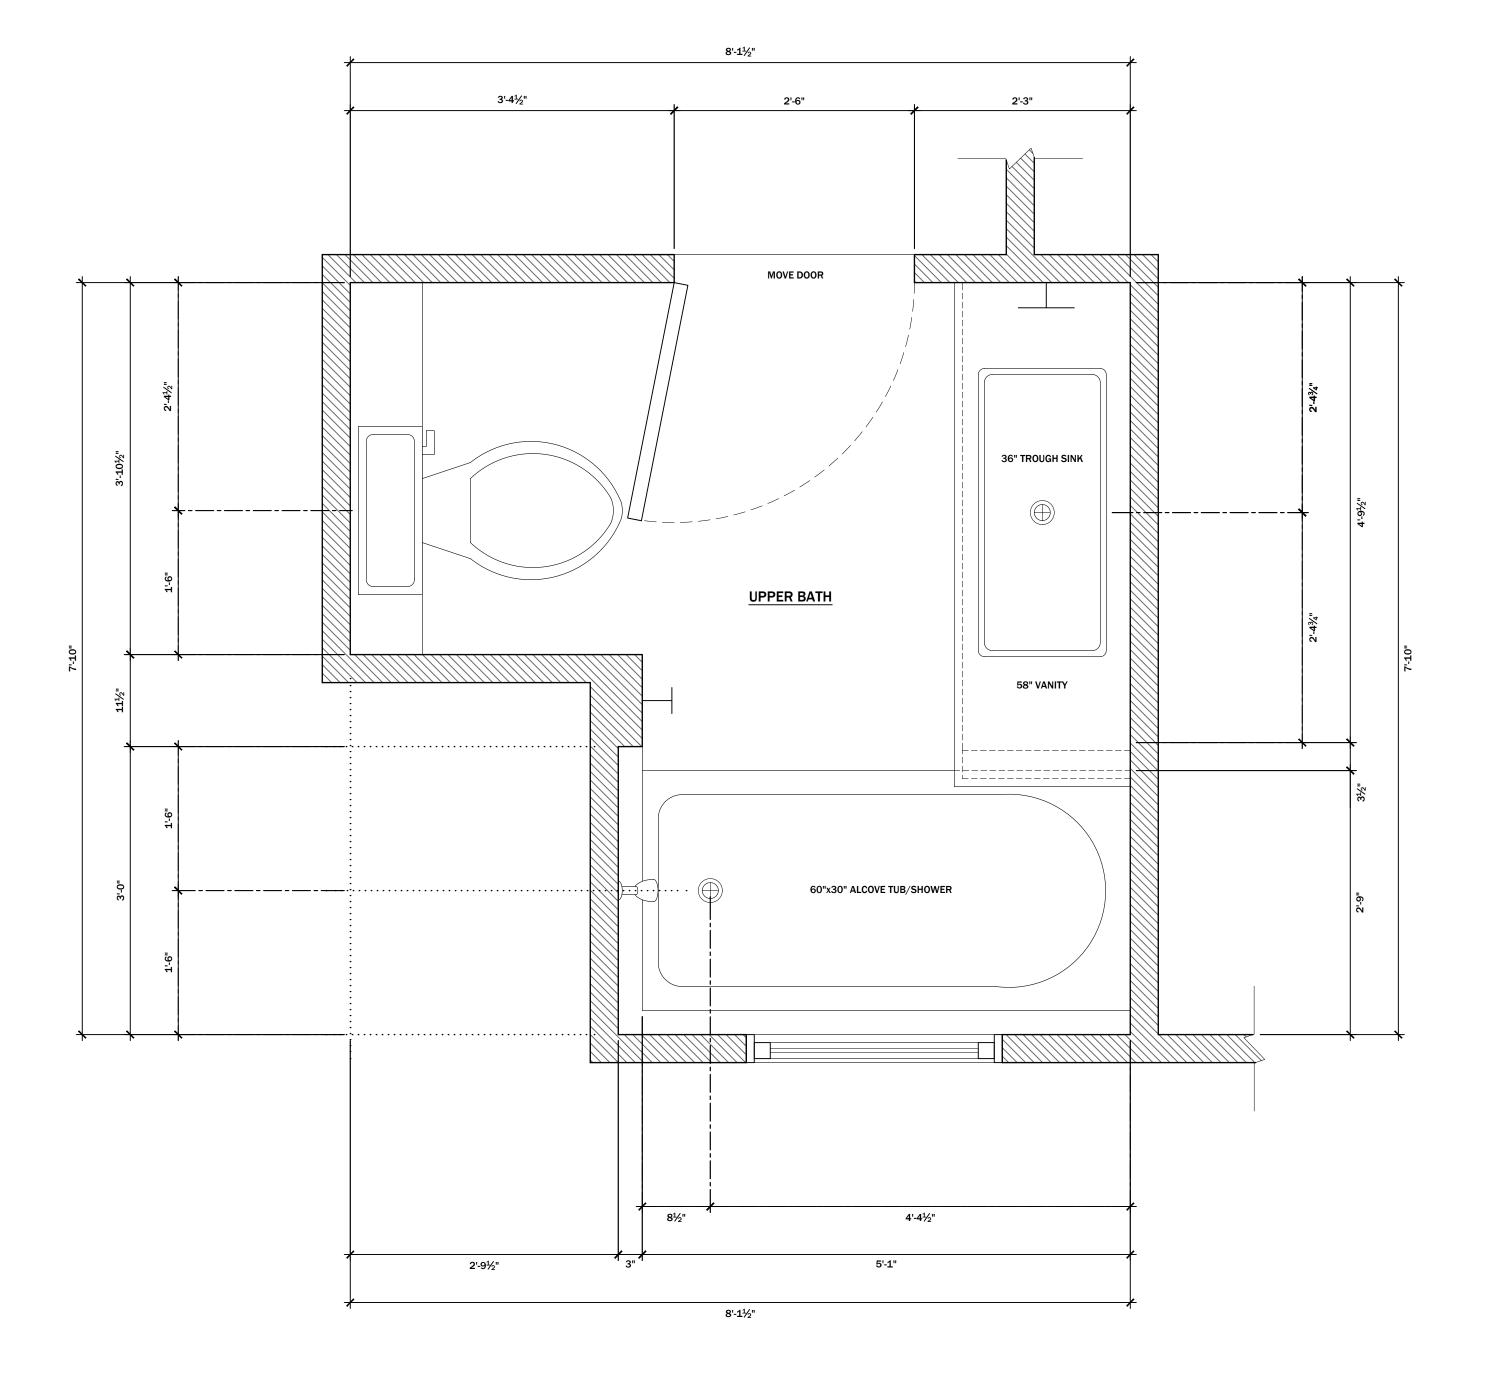




	SHEET TITLE: NEW UPPER BATH FLOOR PLAN	PROJECT: WEBB RESIDENCE 632 PETERSON ST.
-	ISSUE SET:	
	PERIV	IIT SET
	DRAWING DA	
	6/25	/2024
	REVISIONS:	DATE:

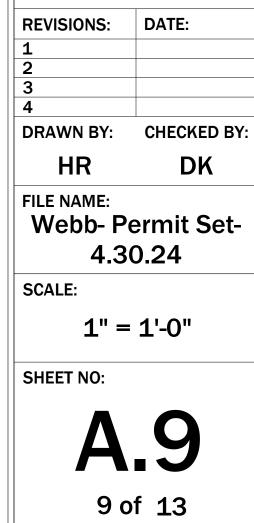

NEW UPPER BATH FLOOR PLAN

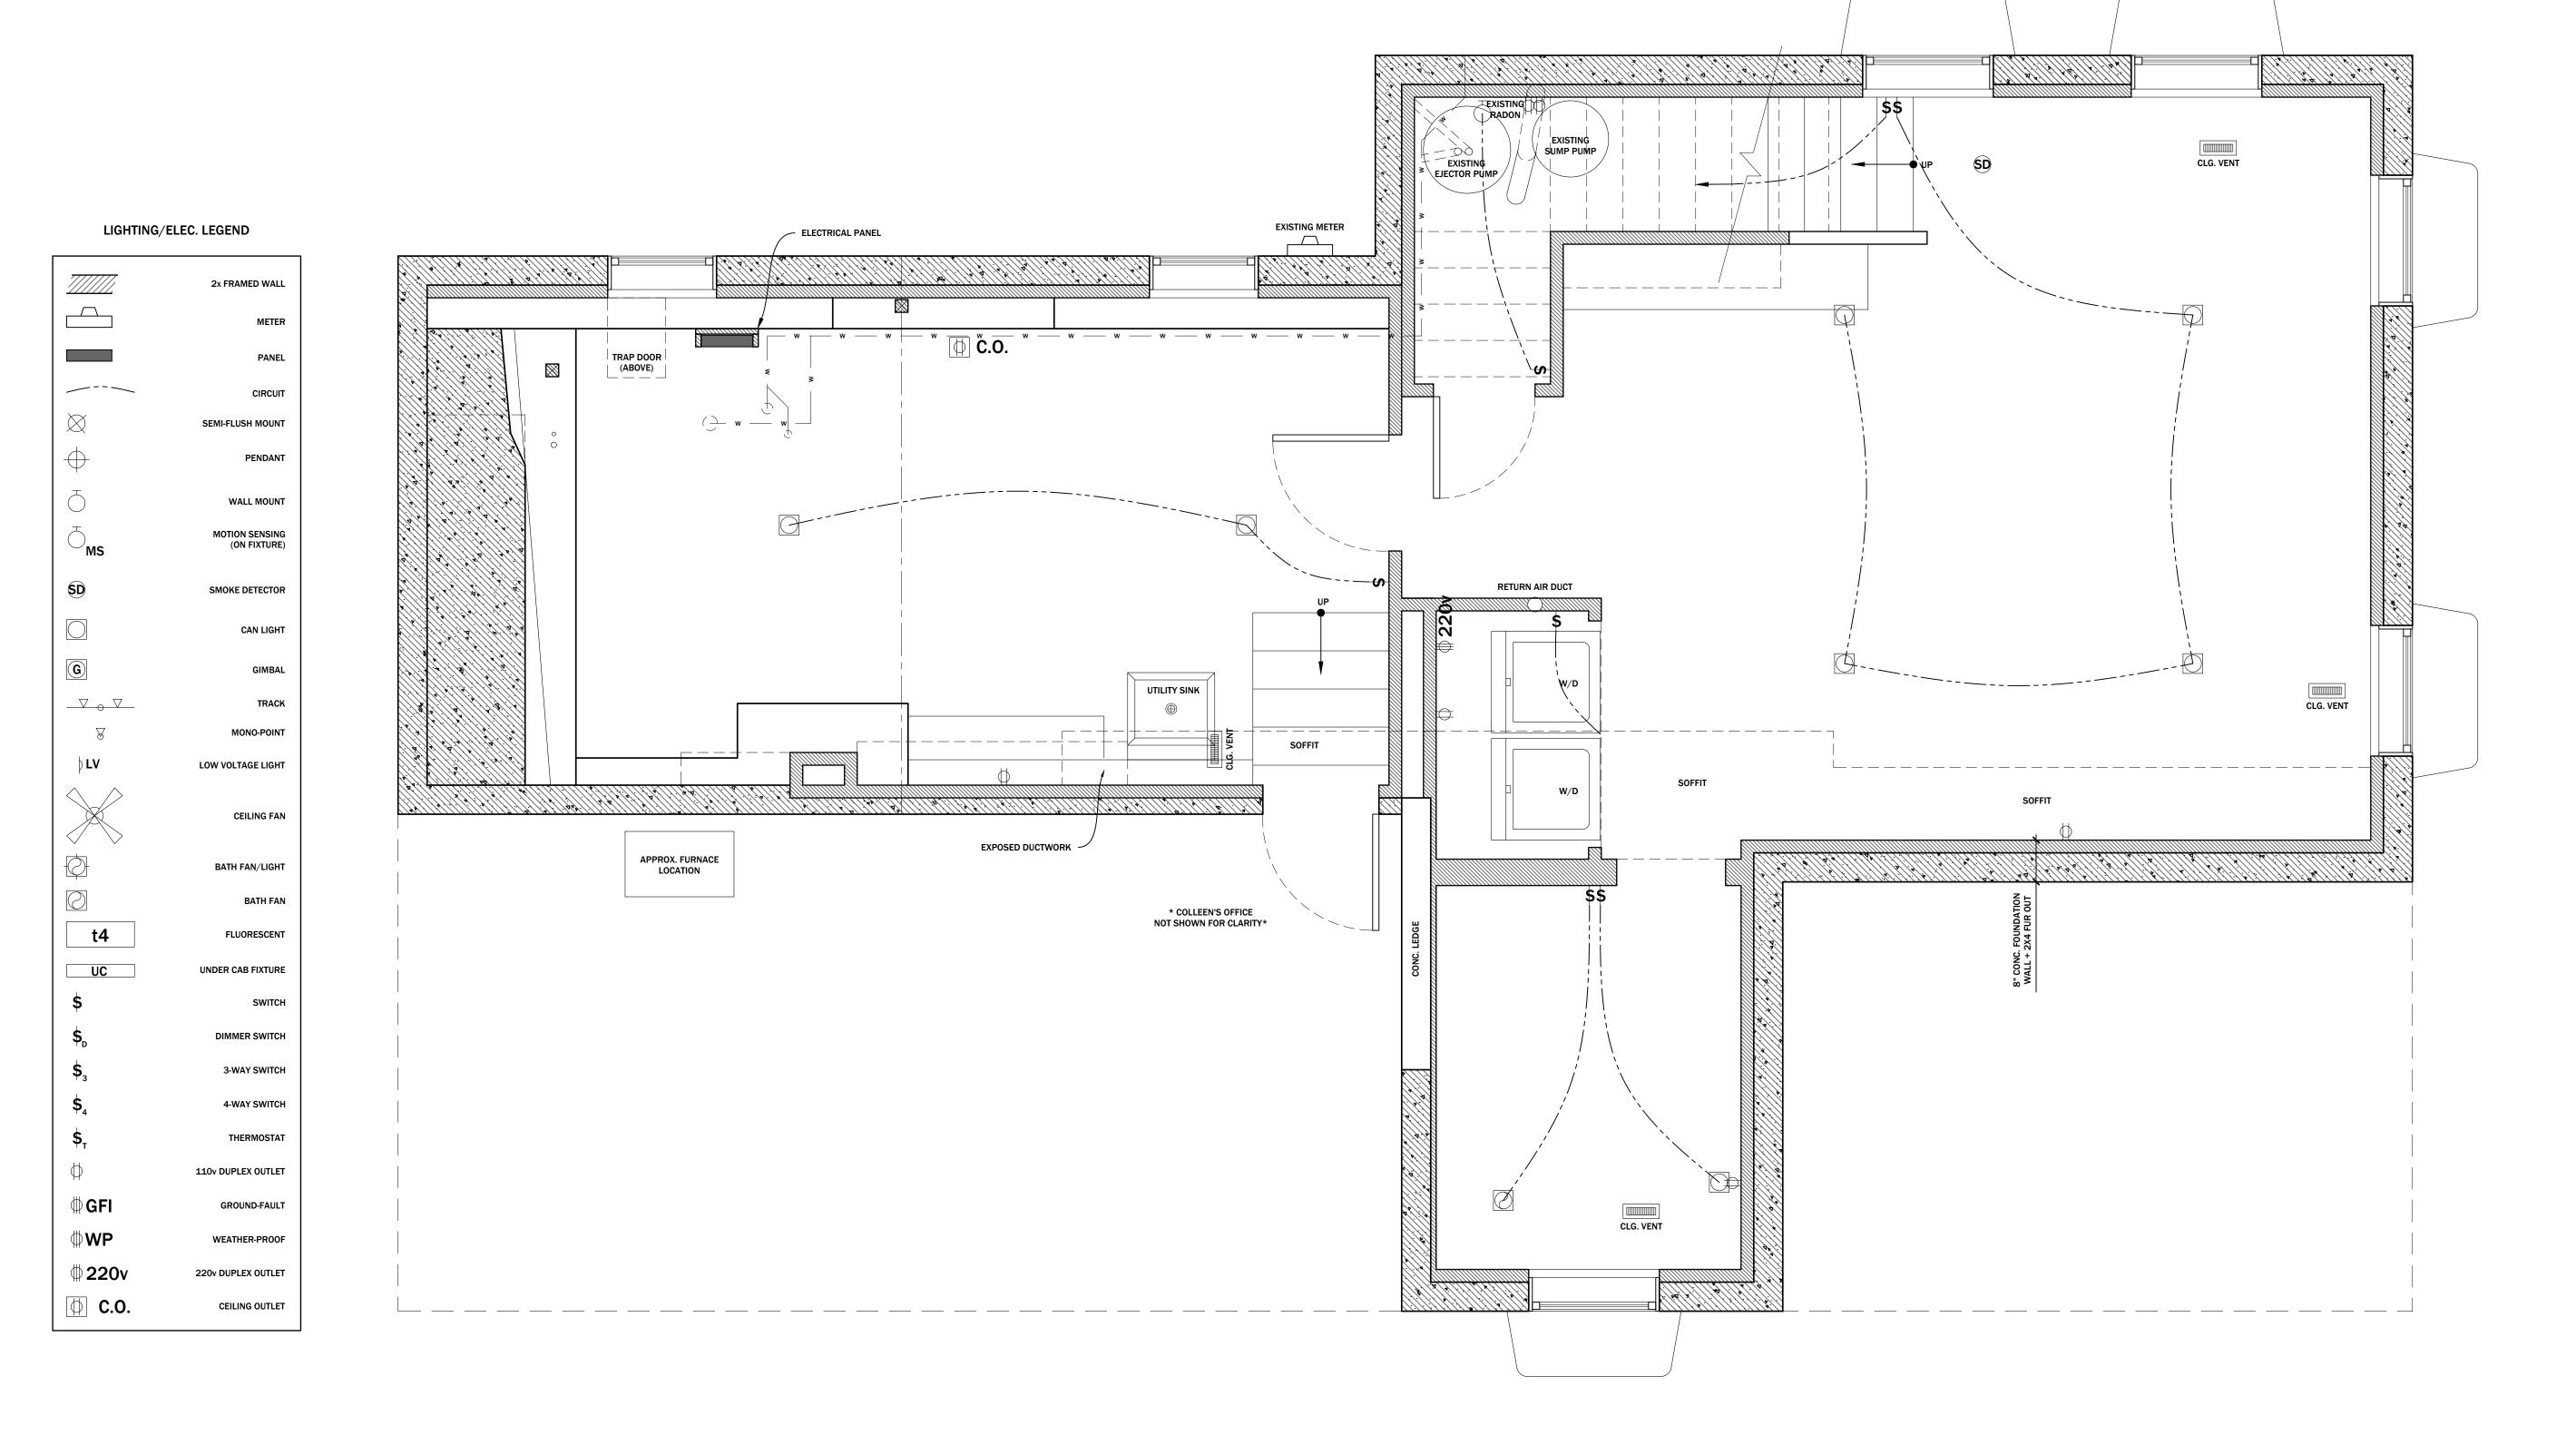

ELEVATE D

ELEVATED DESIGN BUILD

144 RACQUETTE DR
FORT COLLINS, CO 80524

© 2024

EXISTING BASEMENT ELECTRICAL PLAN
PROJECT:
WEBB RESIDENCE
632 PETERSON ST.
FORT COLLINS, CO 80524

ISSUE SET:	
PERM	IIT SET
DRAWING DA	TE:
6/25	/2024
REVISIONS:	DATE:
1	
2 3 4	
4	
DRAWN BY:	CHECKED BY:
HR	DK
FILE NAME:	
Webb- P	ermit Set-
4.3	0.24
SCALE:	
1/2"	= 1'-0"


SHEET NO:


E.110 of 13

EXISTING BASEMENT

ELECTRICAL + MECH. PLAN

SCALE: 1/2" = 1'-0"

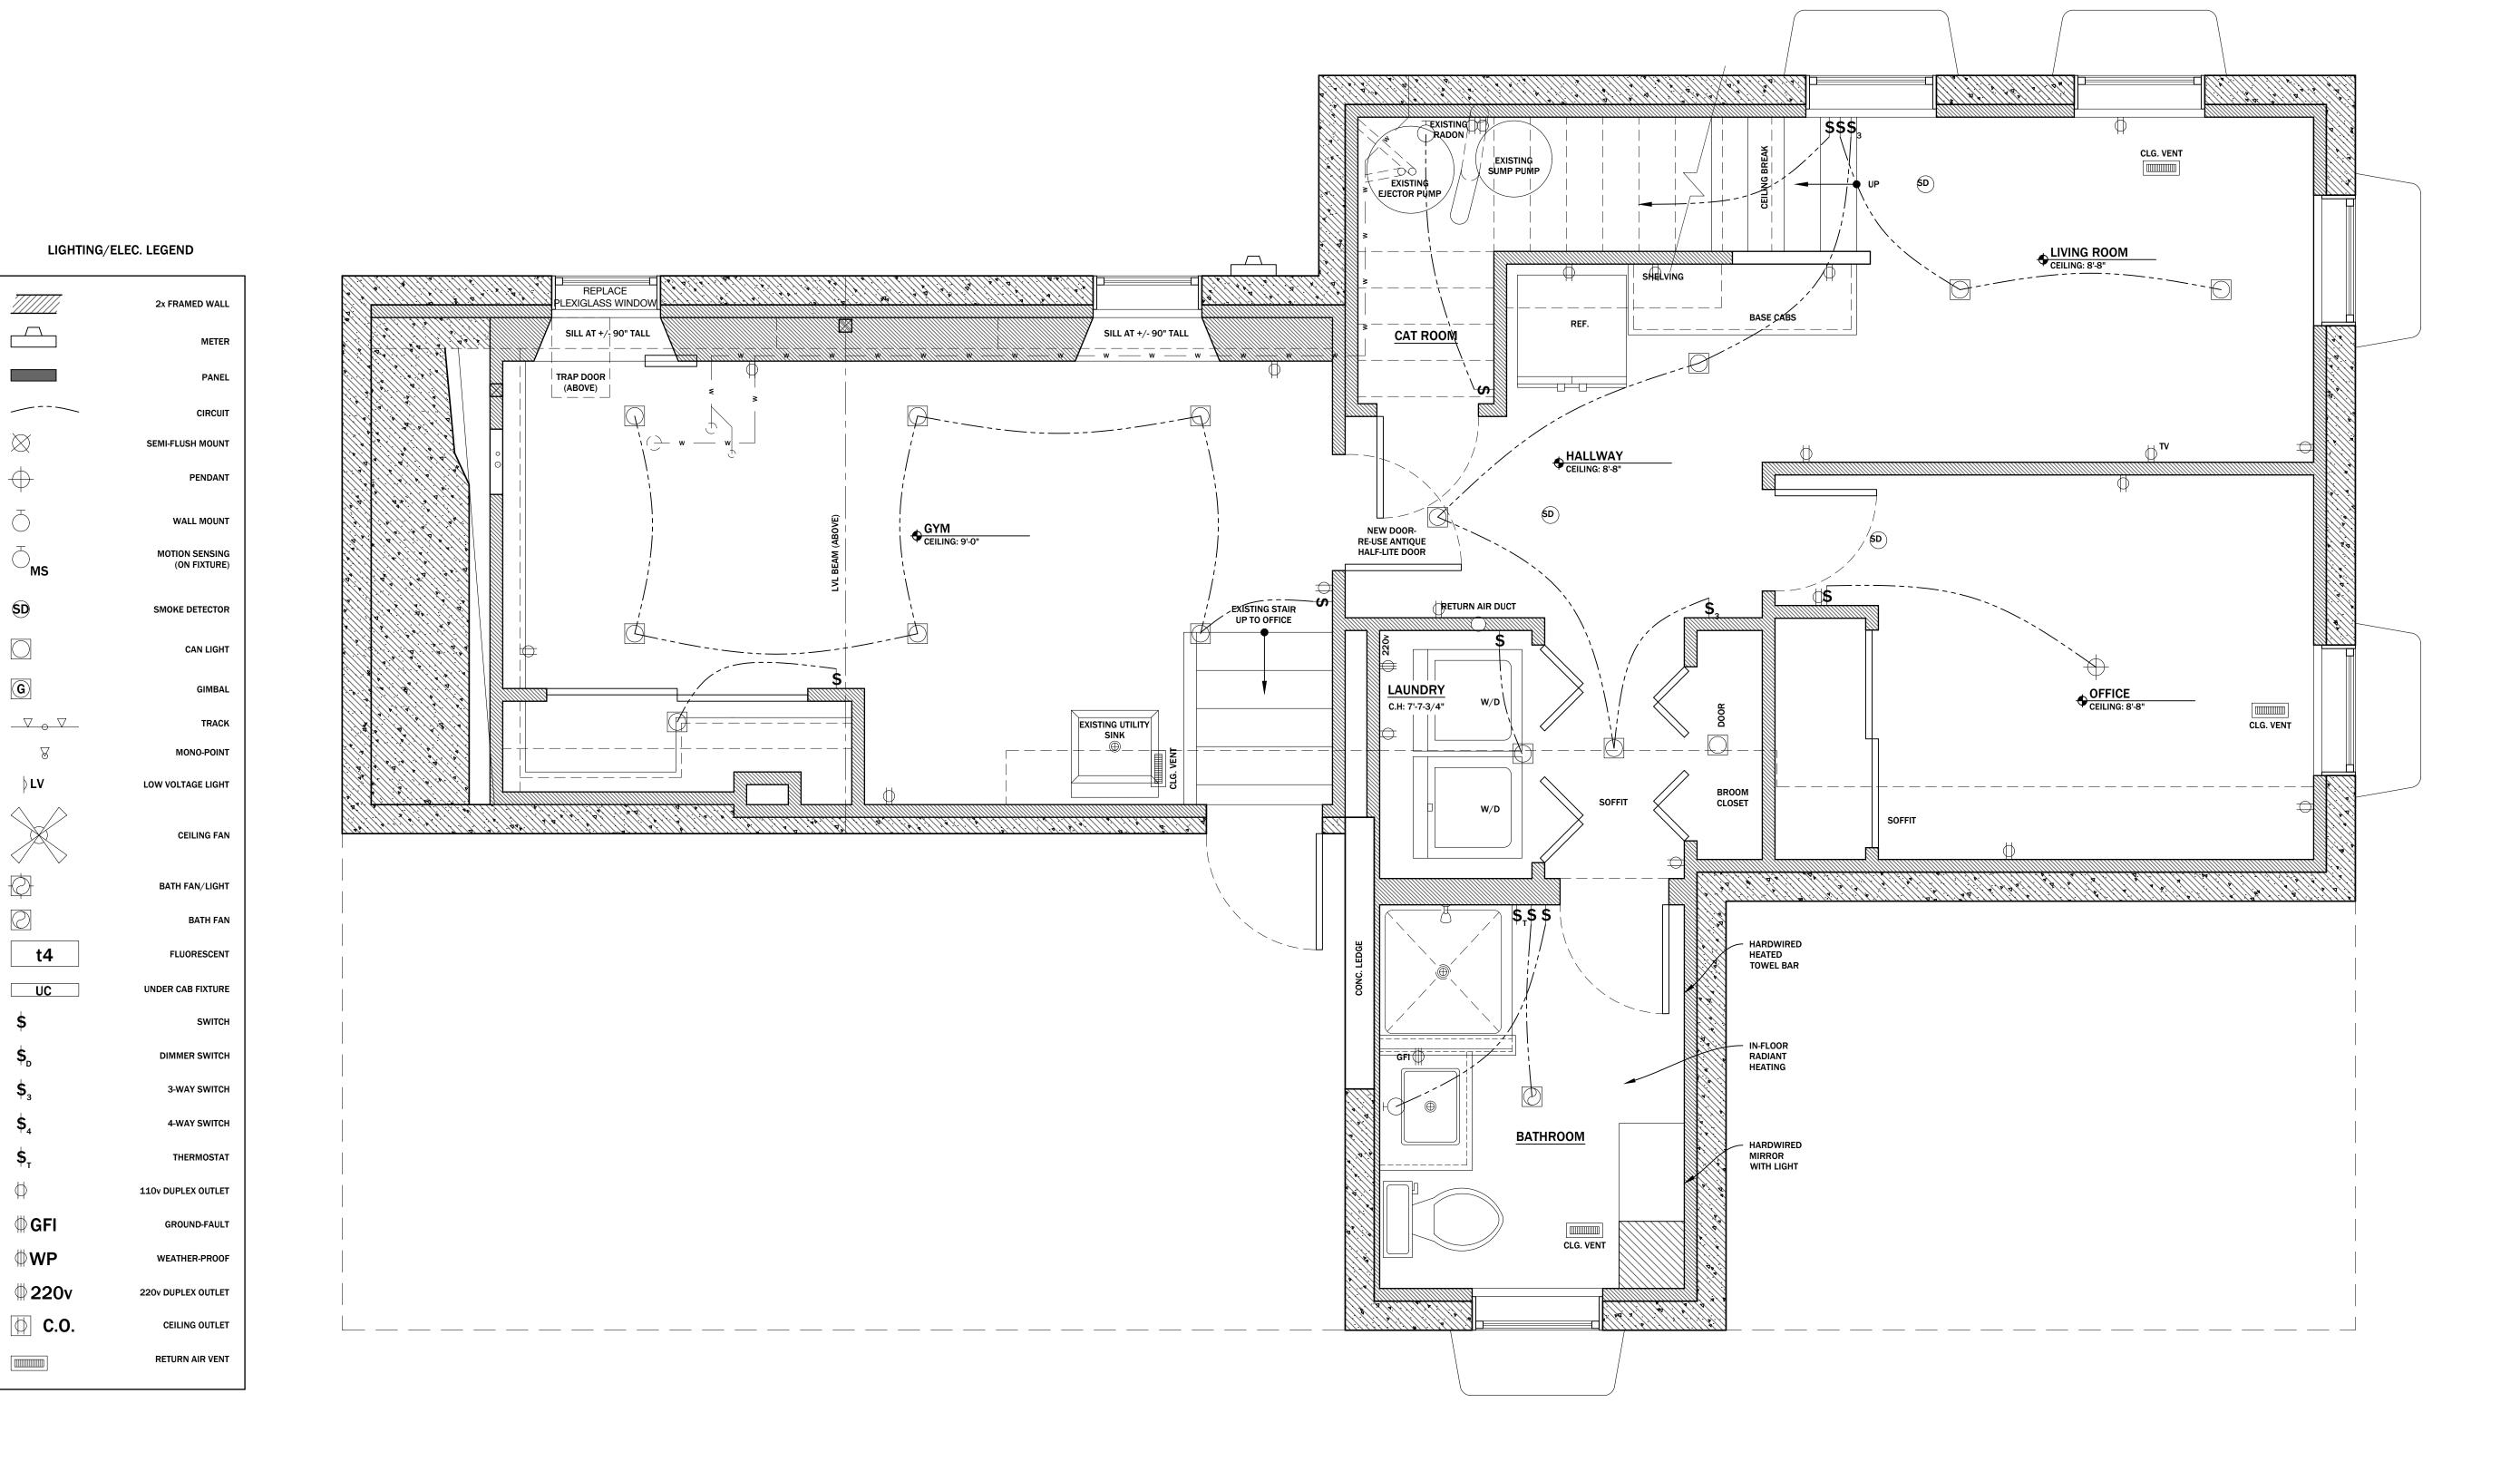

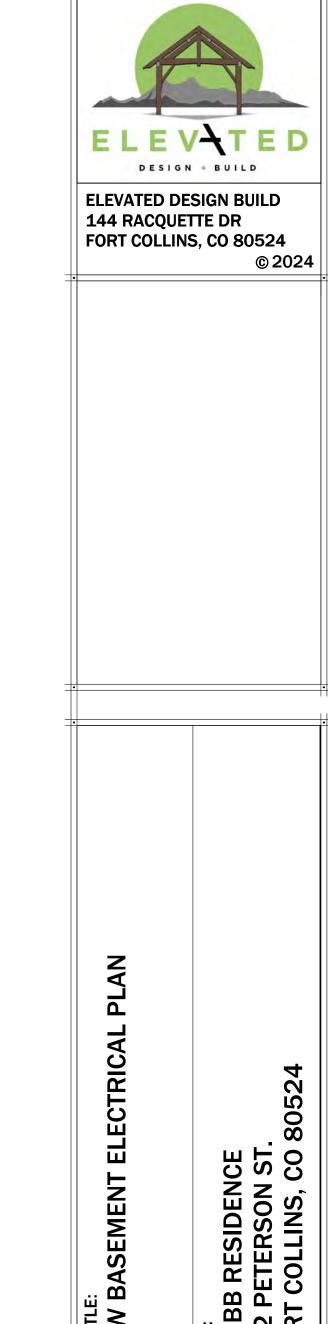

MIT SET
ATE:
5/2024
DATE:
CHECKED BY:
DK
Permit Set- 30.24
= 1'-0"

SHEET NO:


11 of **13**


NEW BASEMENT ELECTRICAL


PLAN

SCALE: 1/2" = 1'-0"

LIGHTING/ELEC. LEGEND

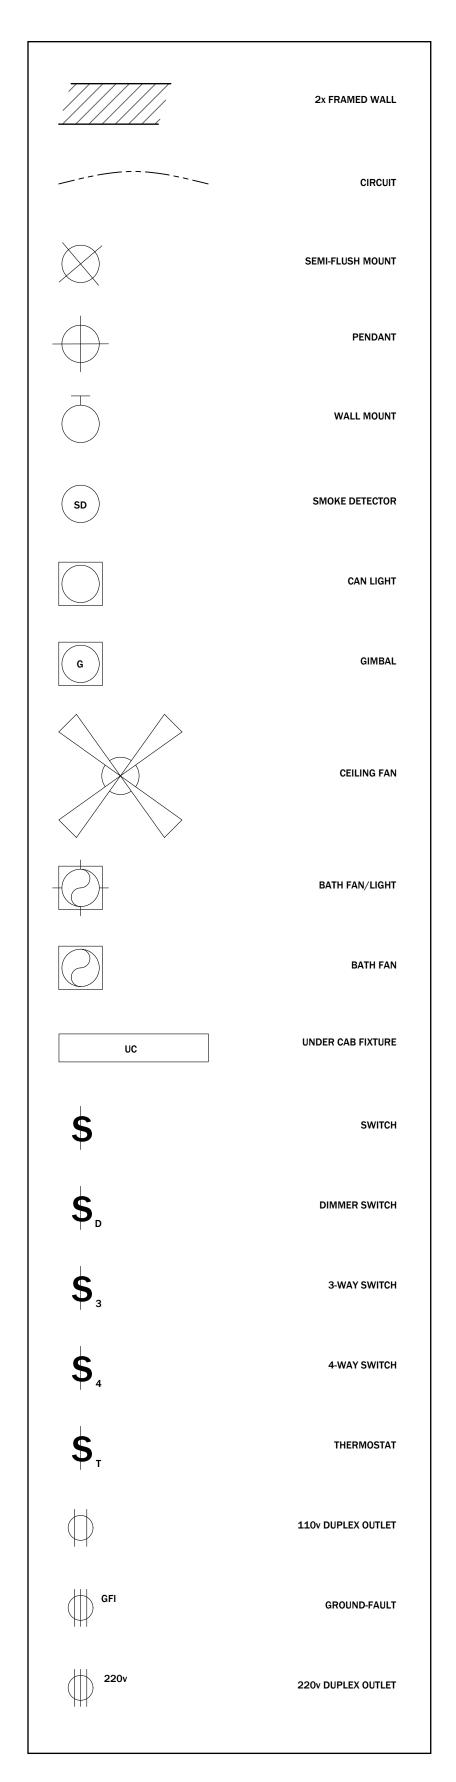

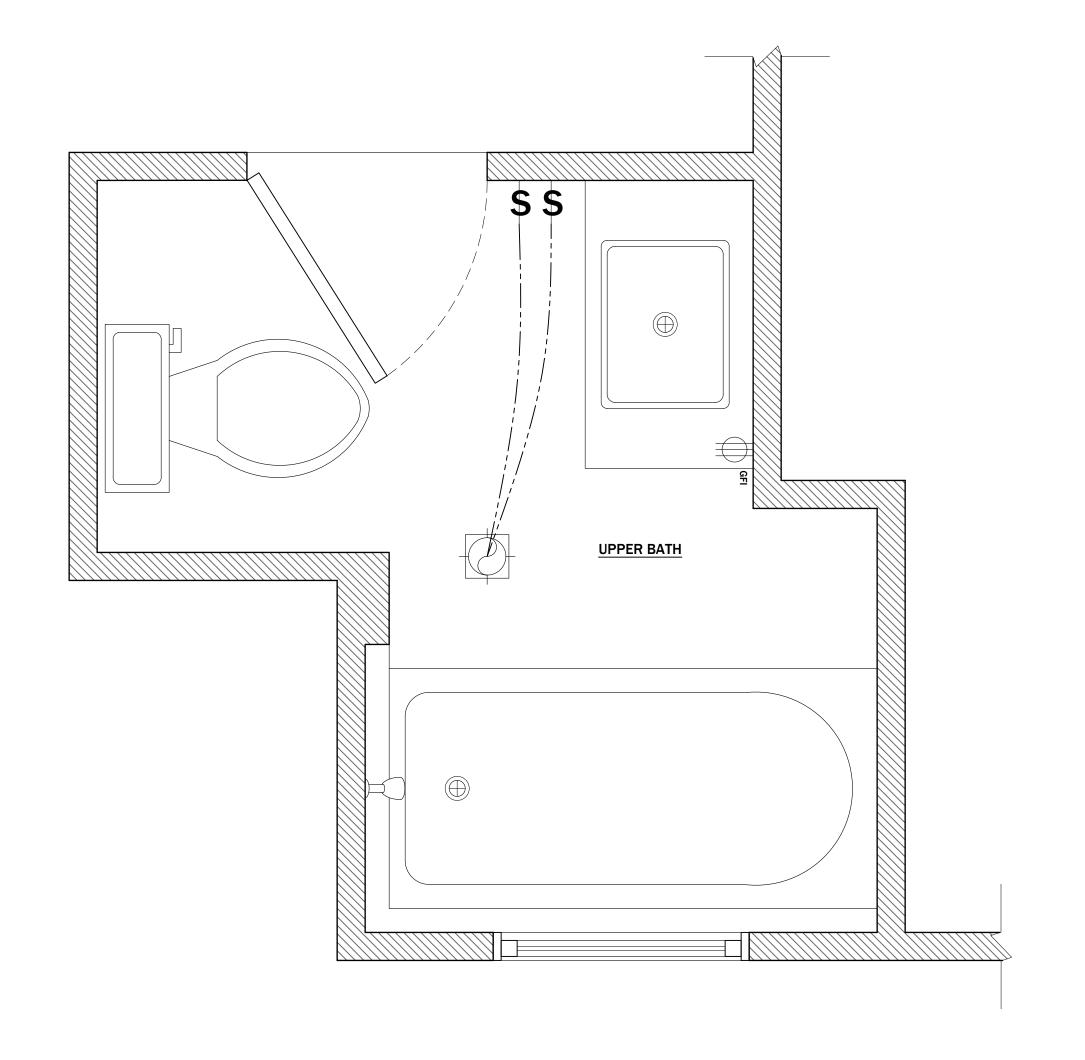

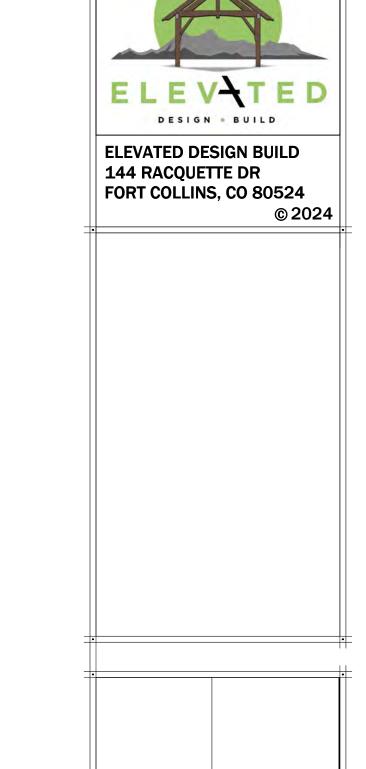



PROJECT:
WEBB RESIDENCE
632 PETERSON ST.
FORT COLLINS, CO 80524


ISSUE SET:	
PERM	IIT SET
DRAWING DAT	 ΓΕ:
6/25	/2024
REVISIONS:	DATE:
1	
2 3 4	
3	
	CHECKED BY:
HR	DK
	ermit Set- 0.24
SCALE:	
1" =	1'-0"



LIGHTING/ELEC. LEGEND

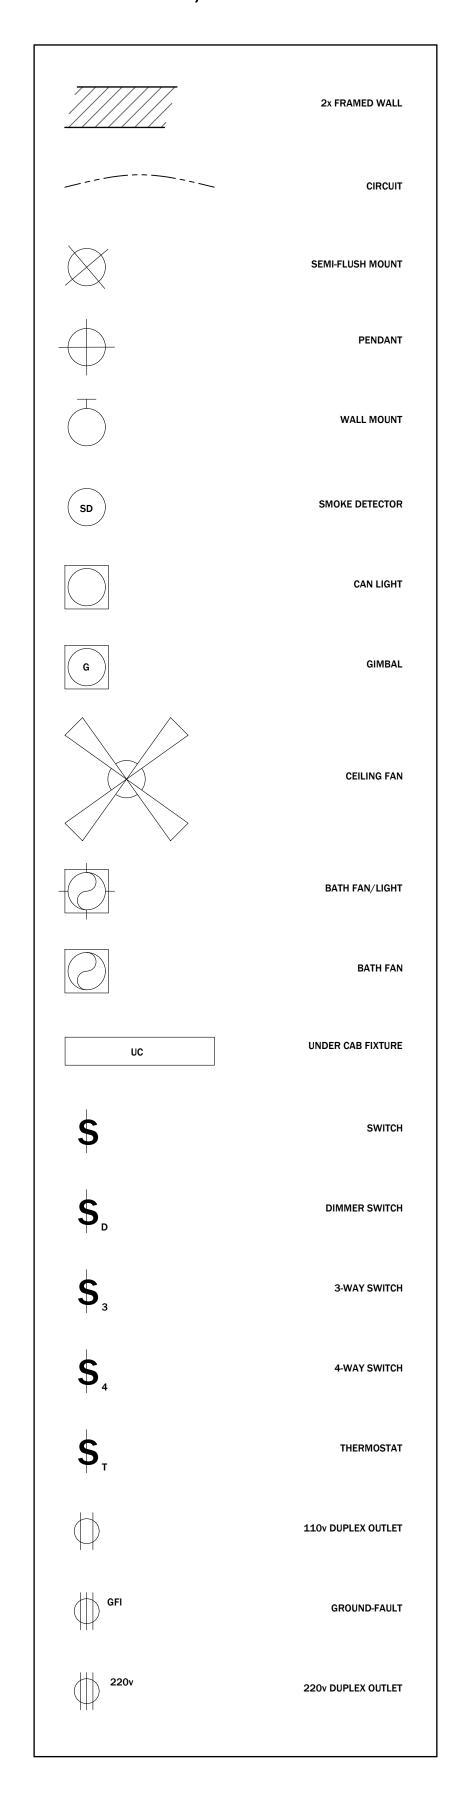

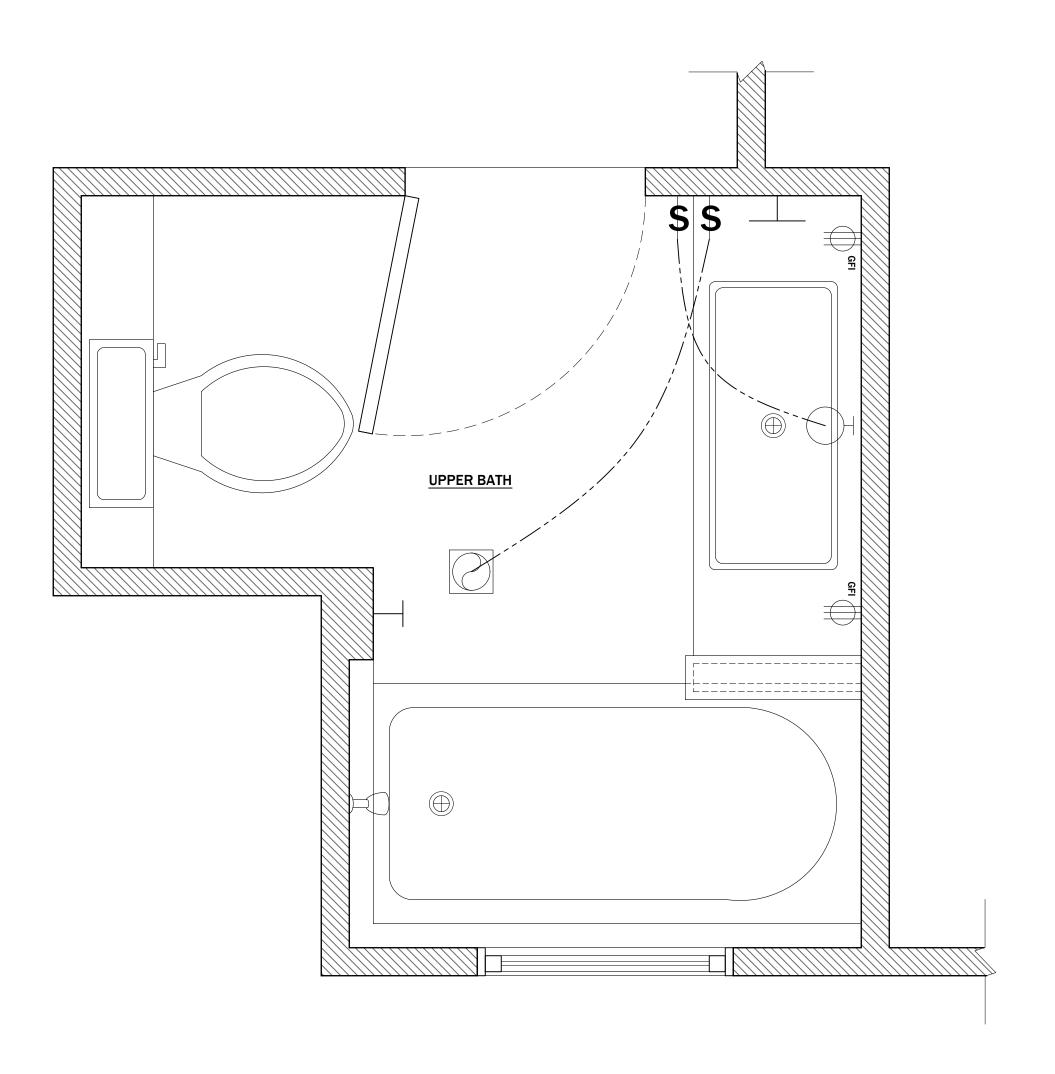

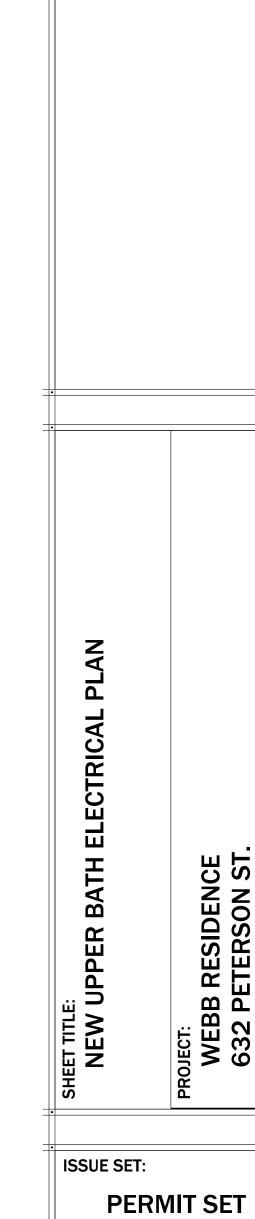

DRAWING DATE:

HR

SCALE:

SHEET NO:

6/25/2024

FILE NAME:
Webb- Permit Set-

4.30.24

1" = 1'-0"

13 of **13**

CHECKED BY:


DK

REVISIONS: DATE:

DESIGN . BUILD

ELEVATED DESIGN BUILD 144 RACQUETTE DR FORT COLLINS, CO 80524 © 2024

			NEW UPPER BATH LIGHTING
2'	1 '	0' 	PLAN
			SCALE: 1" = 1'-0"

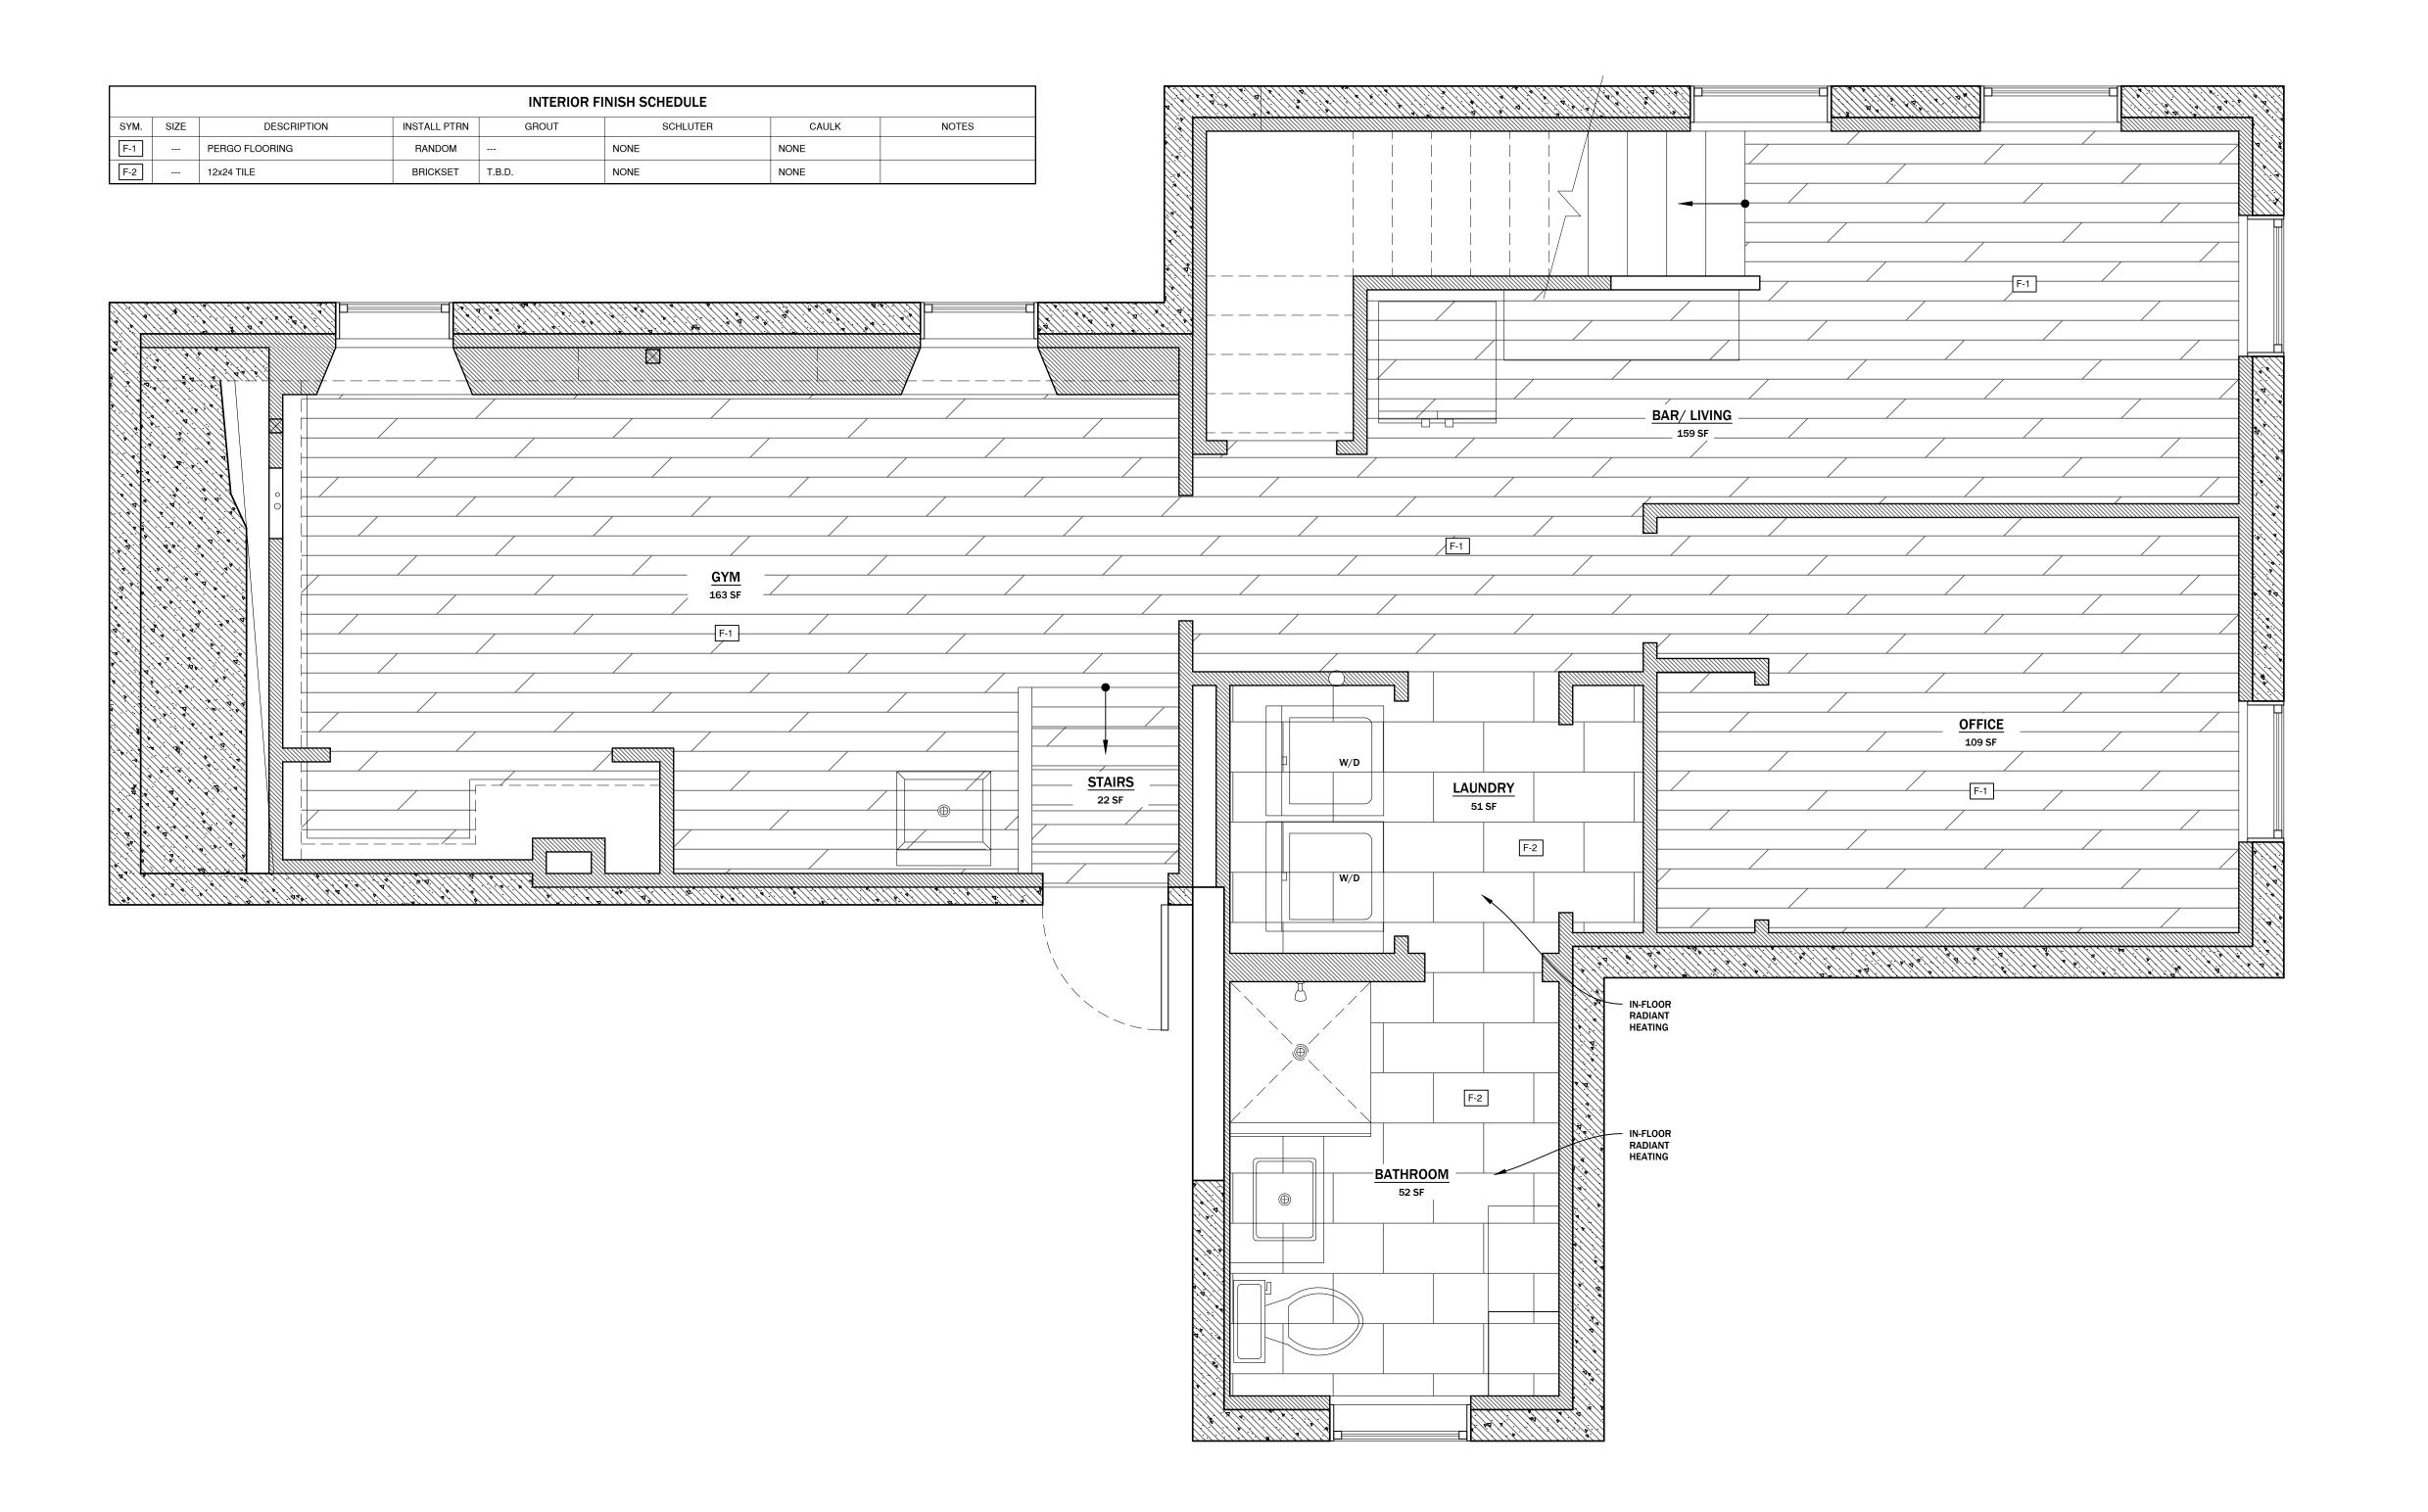





BASEMENT FLOORING LAYOUT DIAGRAM		WEBB RESIDENCE	632 PETERSON ST.	FORT COLLINS, CO 80524
BASEMENT F	PROJECT:	WEBB RESID	632 PETERS	FORT COLLIN


ISSUE SET:	ISSUE SET:		
PERM	IIT SET		
DRAWING DA	TE:		
6/25	/2024		
REVISIONS:	DATE:		
1			
3			
4			
	CHECKED BY:		
HR	DK		
FILE NAME:			
Webb-P	ermit Set-		
4.30.24			
SCALE:			
1/2"	= 1'-0"		
SHEET NO:			


SCALE: 1/2" = 1'-0"

FLOORING LAYOUT DIAGRAM

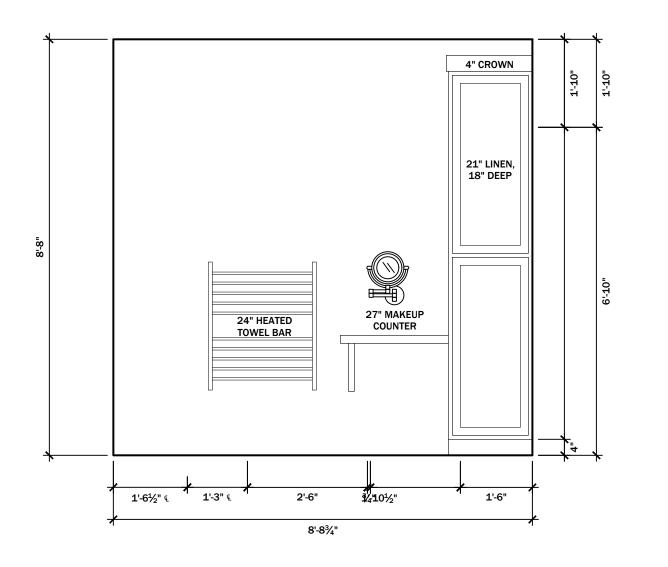

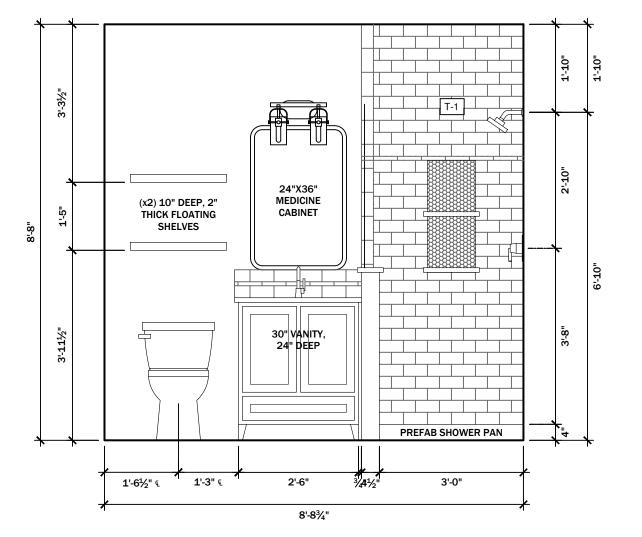

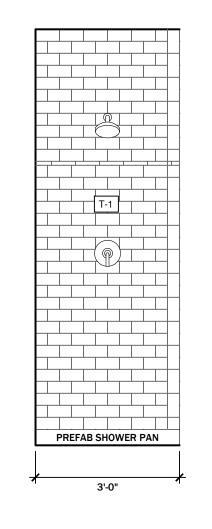


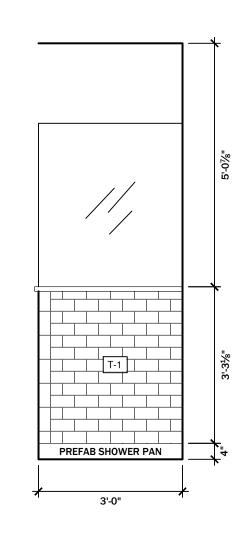





SCALE: 1/2" = 1'-0"

				INTERIOR FI	NISH SCHEDULE		
SYM.	M. SIZE DESCRIPTION INSTALL PTRN GROUT SCHLUTER CAULK NOTES					NOTES	
T-1	3x6	FLORIDA TILE STREAMLINE BUFF	BRICKSET	LATICRETE IRON 97	JOLLY A100 BRUSHED ALUM.EB	SILICONE- IRON	

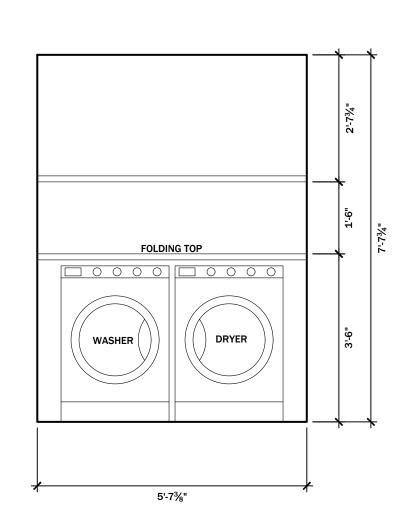

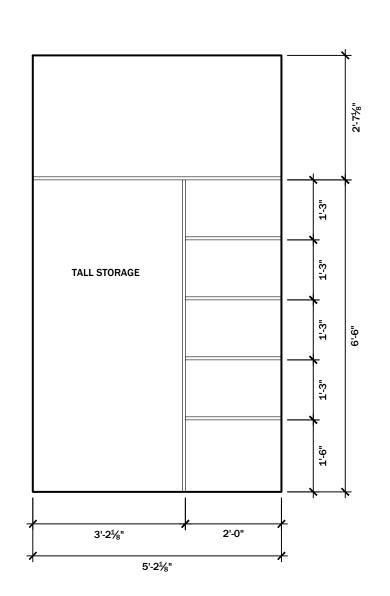

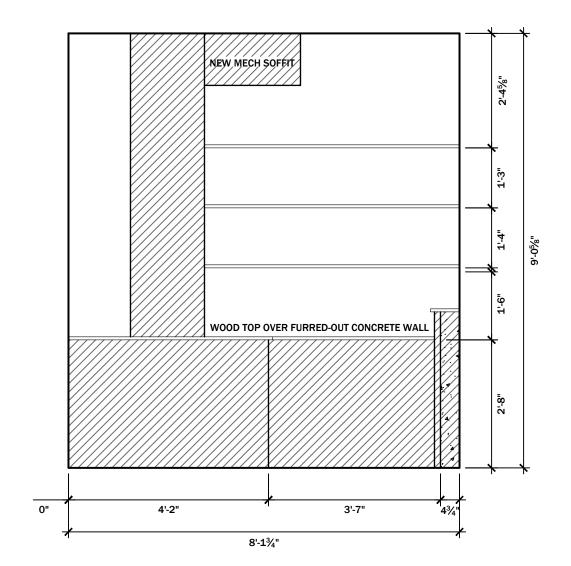

LAUNDRY SHELVING LAYOUT


SCALE: 1/2" = 1'-0"

BROOM CLOSET LAYOUT

SCALE: 1/2" = 1'-0"

GYM CLOSET LAYOUT

SCALE: 1/2" = 1'-0"

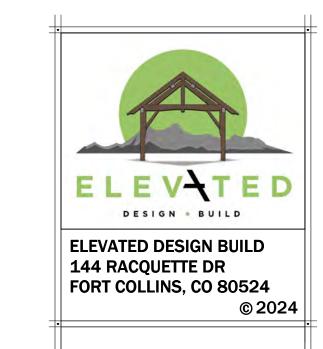


SHEET TITLE:


BASEMENT INTERIOR ELEVATIONS


PROJECT:

WEBB RESIDENCE
632 PETERSON ST.

FORT COLLINS CO 80524

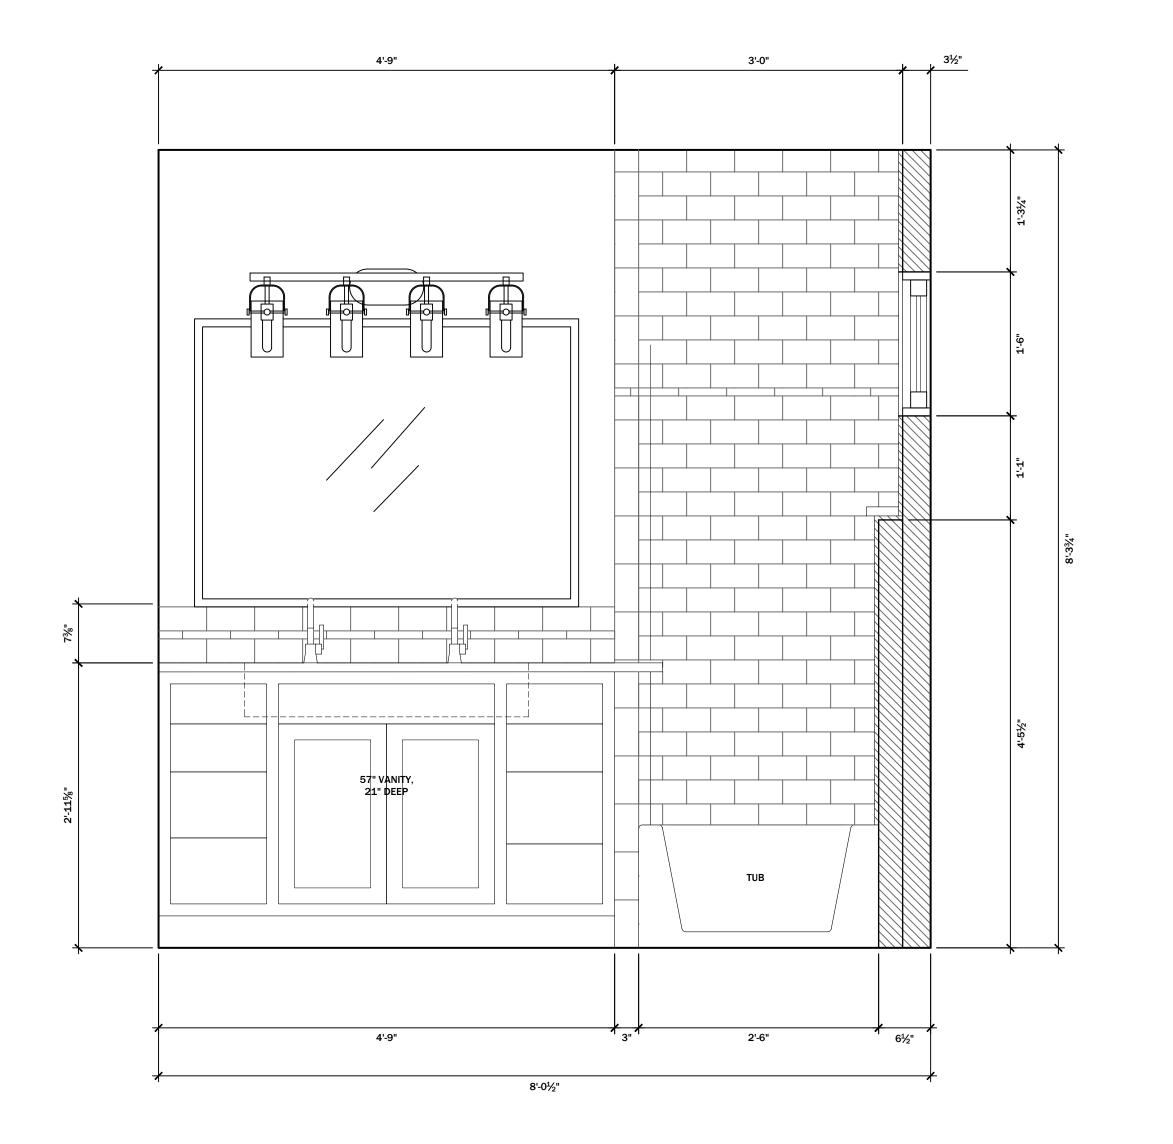

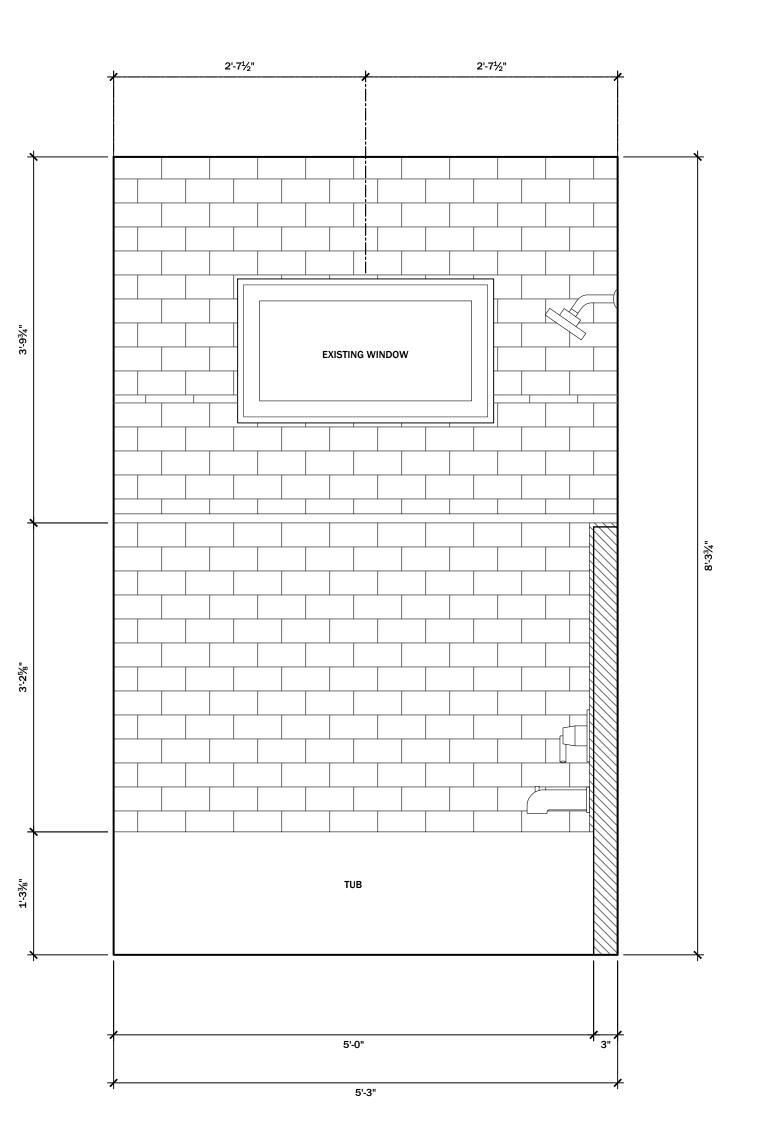

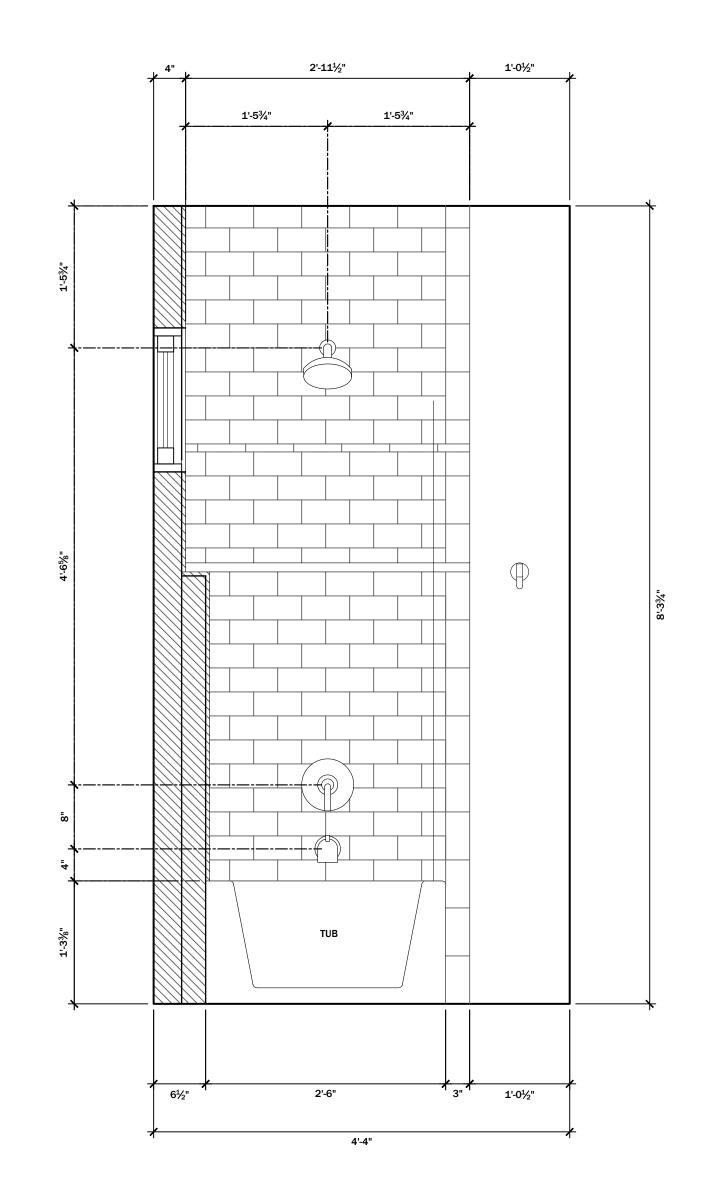





SHEET TITLE: UPPER BATH ELEVATIONS	
PROJECT: WEBB RESIDENCE 632 DETERPONI ST	
FORT COLLINS, CO 80524	

<i>(</i>)	ட	
ISSUE SET:		
PERM	IIT SET	
DRAWING DA	TE:	
6/25	/2024	
REVISIONS:	DATE:	
1 2		
3	_	
A DRAWN BY:	CHECKED BY	
HR	DK	
FILE NAME: Webb- P	ermit Set-	
	0.24	
SCALE:		
	410"	
1" = 1'-0"		
SHEET NO:		
F	.3	

UPPER BATH ELEVATIONS

SCALE: 1" = 1'-0"

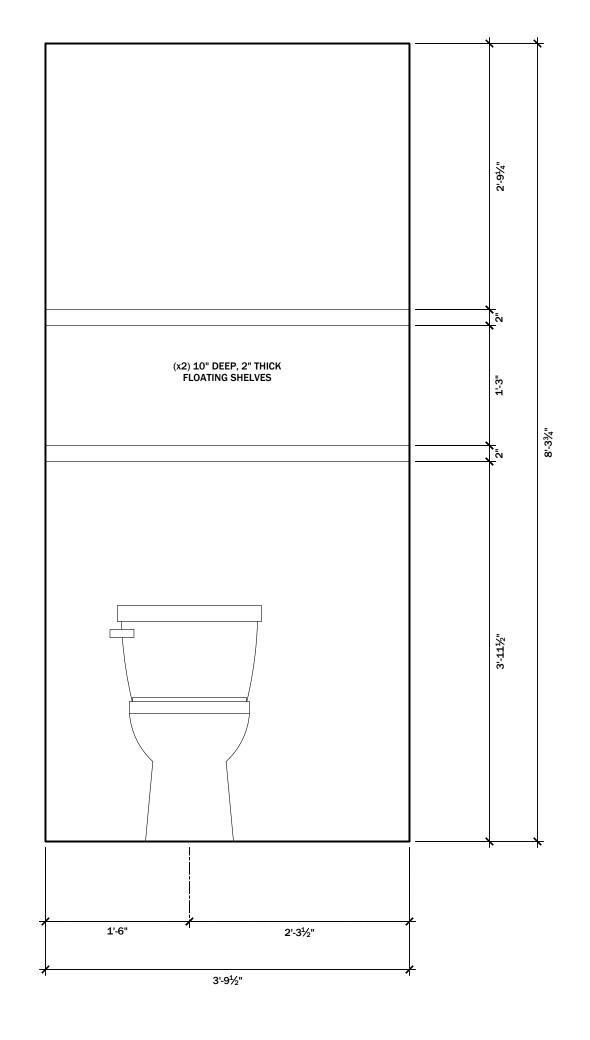

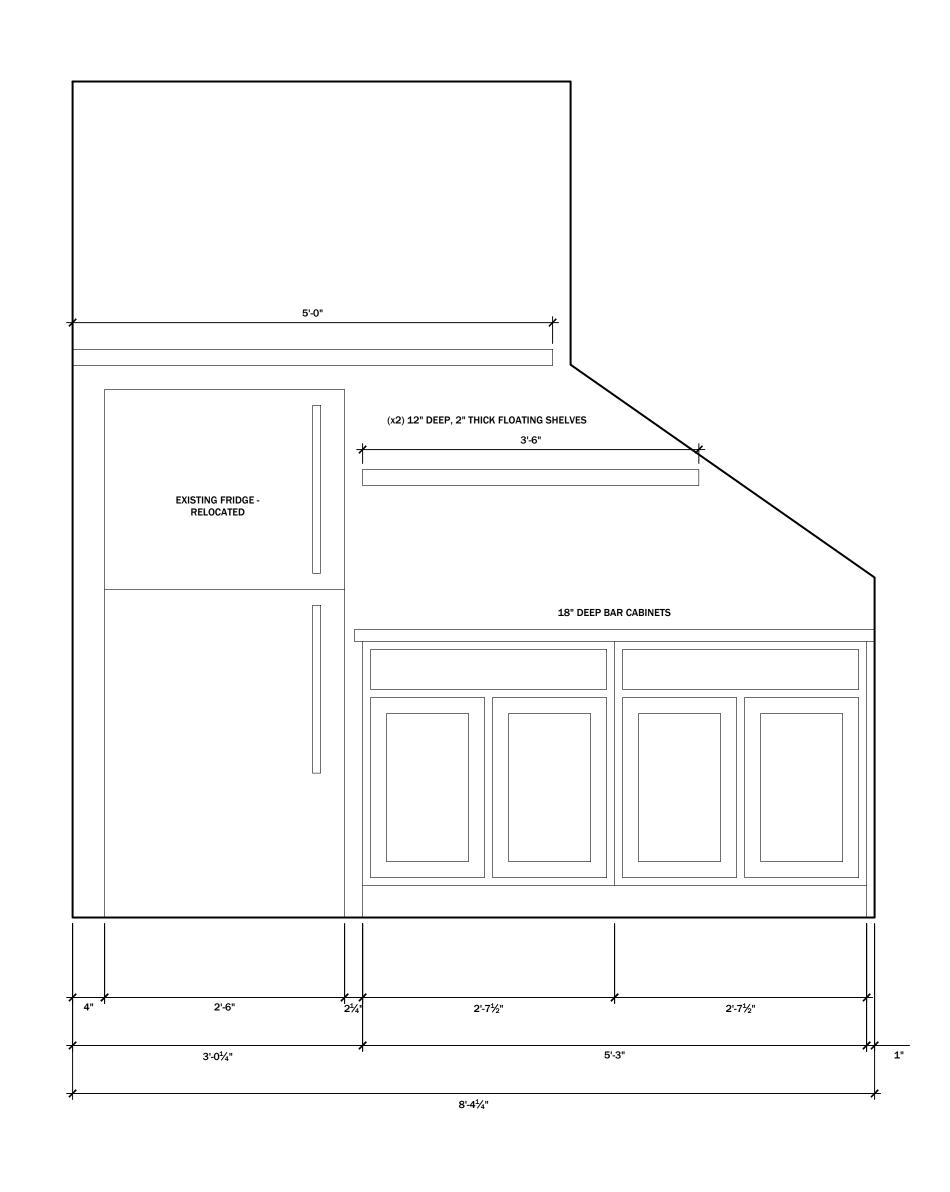



SHEET TITLE: MISC ELEVATIONS	PROJECT: WEBB RESIDENCE 632 PETERSON ST. FORT COLLINS, CO 80524	

SHEE	PROJ V
ISSUE SET:	
PERM	IIT SET
DRAWING DA	TE:
6/25	/2024
REVISIONS:	DATE:
1	
2 3 4	
-	
DRAWN BY:	CHECKED BY:
HR	DK
FILE NAME:	
Webb- P	ermit Set-
4.3	0.24
SCALE:	
1" =	1'-0"
SHEET NO:	



SOLD BY: SOLD TO:


Highland Window and Door Fort Collins 426 S Link Ln Fort Collins, CO 80524-2753 8/5/2024

8/5/2024

OWNER
Seth Johnson

Abbreviated Quote Report - Customer Pricing

QUOTE NAME	PROJECT NAME	QUOTE NUMBER	CUSTOMER PO#	TRADE ID
EDB Peterson	Peterson Bath	6209345		
ORDER NOTES:		DELIVERY NO	OTES:	

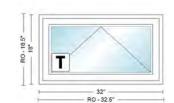

<u>ltem</u>	<u>Qty</u>	Operation	<u>Location</u>	Unit Price	Ext. Price
100	1	Vent	Bath	\$569.52	\$569.52

RO Size: 32 1/2" x 18 1/2" Unit Size: 32" x 18"

100AS 2' 8"X1' 6", Unit, 100 Series Awning, 1 3/8" Setback, White Exterior Frame, White Exterior Sash/Panel, w/White Interior Frame, w/White Interior Sash/Panel, Vent, Dual Pane Low-E SmartSun Tempered Argon Fill Stainless Glass / Grille Spacer, Folding, 2 Sash Locks White, White, Full Screen, Fiberglass

Insect Screen 1: 100 Series Awning, 100AS 32 x 18 Full Screen Fiberglass White

Unit#	U-Factor	SHGC	ENERGY STAR
A1	0.27	0.18	NO

Quote #: 6209345 Print Date: 8/5/2024 4:14:32 PM UTC All Images Viewed from Exterior Page 1 of 2



SOLD BY: SOLD TO:

Highland Window and Door Fort Collins 426 S Link Ln Fort Collins, CO 80524-2753


7/23/2024

LATEST UPDATE 8/5/2024

OWNER
Seth Johnson

Abbreviated Quote Report - Customer Pricing

QUOTE NAME	PROJECT NAME	QUOTE NUMBER	CUSTOMER PO#	TRADE ID
EDB Peterson	Peterson Gym	6142734		
ORDER NOTES:		DELIVERY N	OTES:	

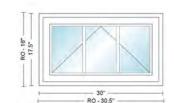

<u>ltem</u>	<u>Qty</u>	Operation	Location	Unit Price	Ext. Price
100	1	Vent	Gym	\$404.52	\$404.52

RO Size: 30 1/2" x 18" Unit Size: 30" x 17 1/2"

100AS 2' 6"X1' 5 1/2", Unit, 100 Series Awning, 1 3/8" Setback, White Exterior Frame, White Exterior Sash/Panel, w/White Interior Frame, w/White Interior Sash/Panel, Vent, Dual Pane Low-E SmartSun Standard Argon Fill Finelight Grilles-Between-the-Glass 3 Wide, 1 High, Specified Equal Light Pattern, White, w/White, 3/4" Grille Bar, Stainless Glass / Grille Spacer, Folding, 2 Sash Locks White, White, Full Screen, Fiberglass

Insect Screen 1: 100 Series Awning, 100AS 30 x 17.5 Full Screen Fiberglass White

Unit#	U-Factor	SHGC	ENERGY STAR
A1	0.27	0.17	NO


Quote #: 6142734 Print Date: 8/5/2024 4:13:14 PM UTC All Images Viewed from Exterior Page 1 of 2

SUB-TOTAL:	\$404.52
FREIGHT:	\$0.00
LABOR:	\$0.00
TAX:	\$0.00
TOTAL:	\$404.52

CUSTOMER SIGNATURE	DATE

Thank you for choosing Andersen Windows & Doors

^{*} All graphics as viewed from the exterior. ** Rough opening dimensions are minimums and may need to be increased to allow for use of building wraps or flashings or sill panning or brackets or fasteners or other items.

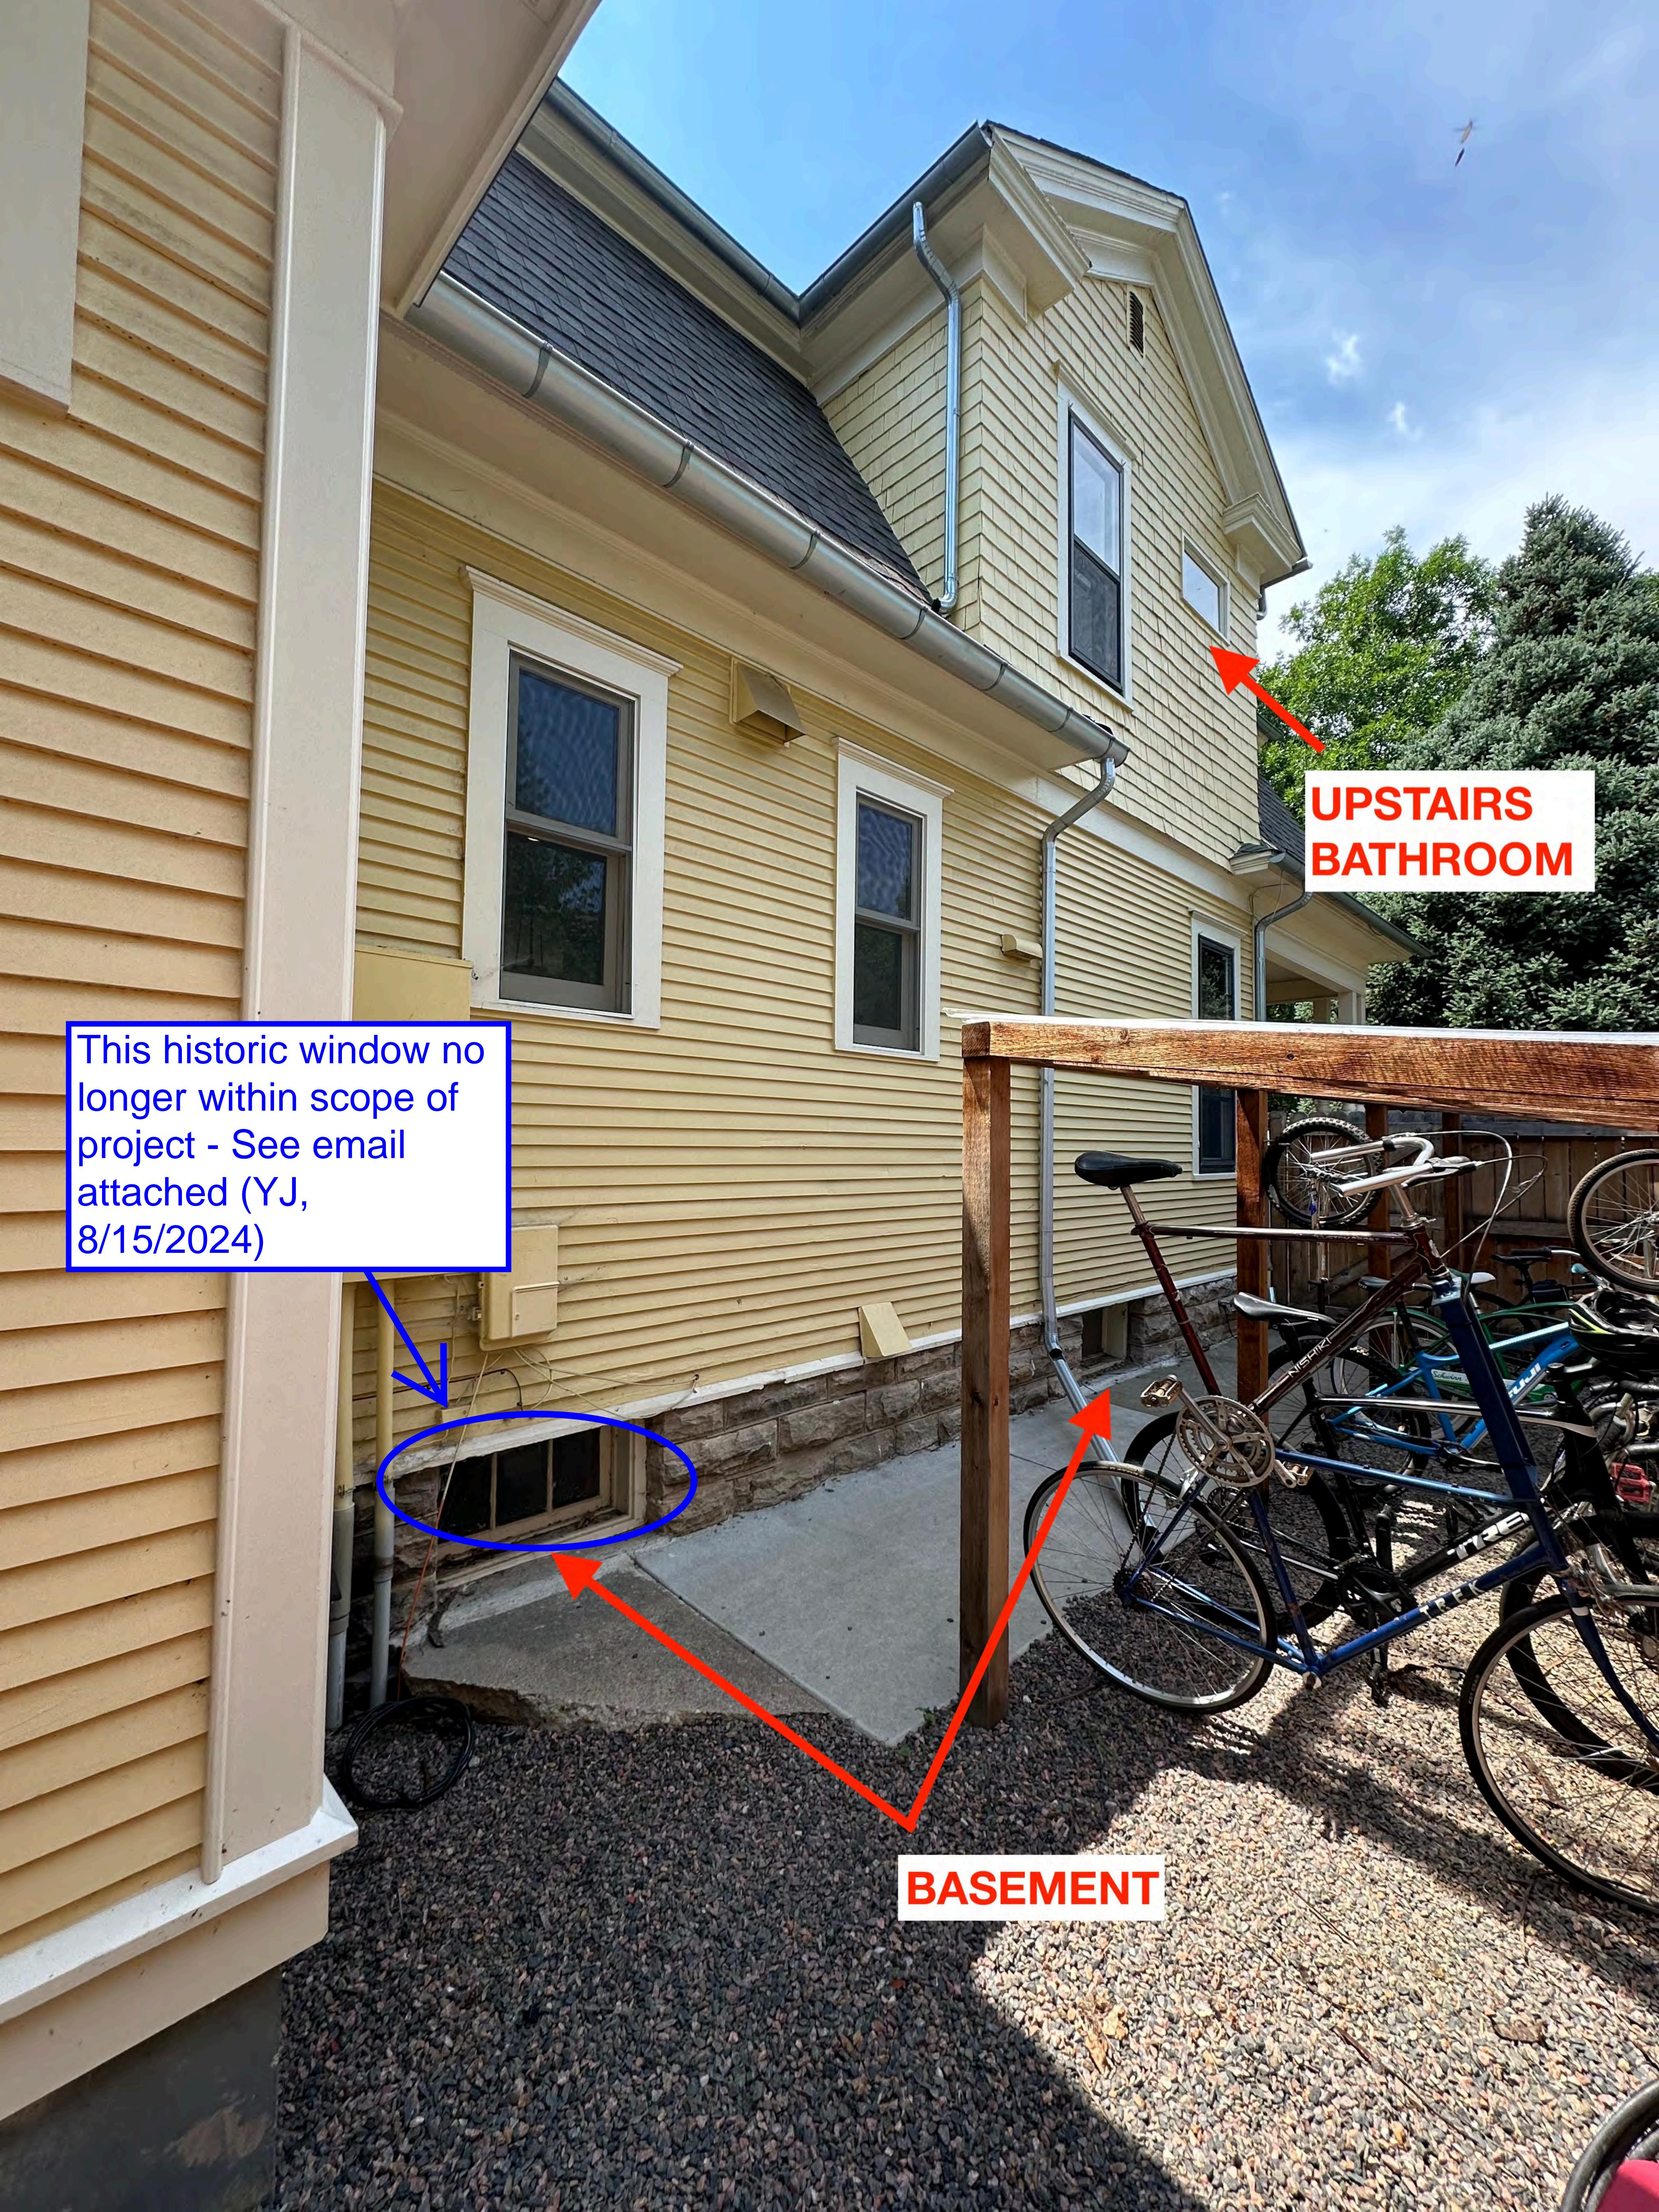











 From:
 David Kaplan

 To:
 Historic Preservation

 Cc:
 Hailey Ruthven

Subject: [EXTERNAL] Re: Re: Permit B2405122 - 632 Peterson St.

Date: Thursday, August 15, 2024 10:42:43 AM

Attachments: Apps - 632 Peterson St. - v2.pdf Plans - 632 Peterson St. - v2.pdf

Good morning Yani,

Please find attached the drawings for the 632 Peterson Remodel where we removed notes about replacing the existing historic window in the basement.

We will be replacing the two non-historic windows: the plexiglass window in the basement, and the window in the shower in the upstairs bath.

I have resubmitted these drawings to the City as well, including a new application with update language regarding the windows.

Please let me know if there is anything else you need from us to move this permit application forward.

Thank you, have a great day!

David Kaplan

General Manager office: (970) 682-8363 x 104 direct: (970) 413-7225 www.ElevatedDesignBuild.com



On Thu, Jul 18, 2024 at 2:47 PM Historic Preservation cpreservation@fcgov.com wrote:

Hi David,

Thanks for sending all of this info over along with the photo set!

As I mentioned in my first email, replacement of historic features is only allowed under the <u>Secretary of the Interior's Standards for Rehabilitation</u> in cases where deterioration is so severe that repair is not possible (Standard 6), and then when replacement of historic material is warranted, replacement should be done in-kind.

Looking at the photos, it appears that the single-lite basement window is a replacement, the multilite window is historic, and it's hard to tell from the photos about the upper-level bathroom window, but it is likely not historic. Your project doesn't conform to the Secretary of the Interior's Standards right now, and so it can't be approved, but here are some suggestions that would help bring the project into compliance to make it approvable:

- Single-lite basement window
 - Because this window is not historic, it can be replaced. Vinyl is not an approvable material for the replacement because it's not compatible with the historic nature of the property and because the material is not durable in comparison to other products - The City's Energy Code Specialist always advises us that vinyl windows tend not to hold up as well as other materials, especially in basements, where seals tend to quickly fail. Any non-vinyl material should be okay, though (e.g., wood, fiberglass, etc.)! I'd also encourage you to select a design with those 3 vertical lites (or with a non-integrated grille simulating that design) to be more similar to the other window, but it's not required.
- Multi-lite basement window
 - This window is historic, and after reviewing our physical project files, it was the termite-damaged unit that was repaired/restored. That project happened in 2006 as a Landmark Rehab Loan project. Because this window is historic, the expectation is that it is repaired if maintenance is needed rather than being replaced. If you think the window is so deteriorated it has to be replaced, I'd need to connect you with a historic window specialist to help make that determination – In this case, since Empire Carpentry did the 2006 repair, I'd most likely reach out to them for that determination. If you think the window is repairable, please send some info about how you propose to repair the window, and it can most likely be approved.
- Upper-floor bathroom window
 - We do not have any historic photos of the house from this side on file, and there are also no permit records for adding/modifying a window in this location (but that's not surprising because windows didn't require permits until recently). With that said, looking at the windows and trim on the rest of the house, I find it likely that this window either replaced a 1/1 double-hung window like its neighbor or that it was added in a new opening. For that reason, this window can be replaced, but again,

Ι share y the S h m you.

vinyl would not be an approvable material.
I hope that helps! Please let me know if you need any more clarification. Otherwise, please your revised plans with me to review. I'm also going to update my "hold" in the permitting software to let the Building Services team know that you're working on revisions based on historic preservation regulation and that they're going to be receiving updated materials from
Take care,
Yani
YANI JONES